



3D - Perspective



Trunk Road - Servitude Position



AREA SCHEDULE

941m²

35%

1.0

0.050

35%

RESIDENTIAL 1 / SINGLE RESIDENTIAL ZONE

5m REAR & SIDE, 10m STREET BOUNDARY

SINGLE RESIDENTIAL ZONE

3.14%

307m²

NEW BUILDING AREA

GROUND FLOOR AREA
BASEMENT FLOOR AREA

UNCOVERED PATIO AREA

COVERAGE

COVERAGE ALLOWED

TOTAL BUILDING

ZONING

KNYSNA USE ZONE

HEIGHT PERMITTED

PROPERTY OPEN AREA

COVERAGE PERMITTED

BUILDING LINES


FAR ALLOWED

FAR / BULK FACTOR

Locality Plan

PLUMBING PLAN LEGEND

PLUMBING LEGE	ND
	Ø 160mm SUB-SOIL MAIN DRAIN LINE
	Ø 110MM uPVC SUB-SOIL DRAIN LINE
	Ø 50MM uPVC SUB-SOIL DRAIN LINE
	MUNICIPAL SEWER LINE
	HOT WATER
	COLD WATER
Ф	HOT WATER POINT
⊕	COLD WATER POINT
®	RAINWATER HARVESTED WATER POINT 680 ABOVE FF
\oplus	ELECTRIC GEYSER
=	GAS GEYSER
•	Ø 110MM DRAIN IN SECTION OR PLAN

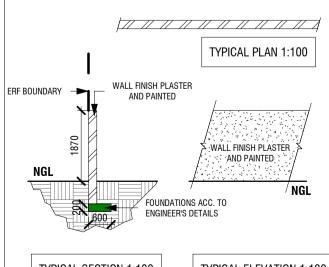

TYPICAL SECTION 1:100 TYPICAL ELEVATION 1:100

Boundary Wall Detail

5

Huis van Niekerk

GENERAL NOTES:

ALL MATERIALS AND CONSTRUCTION METHODS TO COMPLY WITH THE NATIONAL BUILDING REGULATIONS (ACT №. 103 OF 1997) INCLUDING ALL REVISIONS AND ALL APPLICABLE BYLAWS OF THE CONCERNED LOCAL AUTHORITY. ALL DIMENSIONS TO BE VERIFIED ON SITE AND NO DRAWING IS TO BE SCALED. ANY DISCREPANCIES OR CONTRADICTIONS MUST IMMEDIATELY BE POINTED OUT TO THE ARCHITECT FOR CORRECTION OR EXPLANATIONS REFORE ANY CONSTRUCTION PROCESS.

EXPLANATIONS BEFORE

DRAINAGE NOTES:

ALL GUTTER IN OPEN AIR ALL SOILPIPES TO HAVE MINIMUM FALL OF 1:40 IE'S AT ALL CHANGES OF DIRECTIONS AND JOINTS

IE'S AT ALL CHANGES OF DIRECTIONS AND JOINTS
IE'S TO HAVE MARKED COVERS AT GROUND LEVEL
PIPES UNDER BUILDINGS OR WALLS TO HAVE REINFORCED FOUNDATION OVER

NO CHANGE OF DIRECTION OR JUNCTION UNDER BUILDING
ALL WASTEPIPES TO BE 500mm & FULLY ACCESSIBLE
ALL WASTEPIPE APPLICATIONS ON STUBSTACKS TO BE INDIVIDUALLY ANTI-

ALL WASTEPIPES TO BE 500mm & FULLY ACCESSIBLE
ALL WASTEPIPE APPLICATIONS ON STUBSTACKS TO BE INDIVIDUA
SIPHONED WITH 51mm ANTI-VACUME TRAP
ALL WASTEWATER APPLICATIONS TO HAVE WATERTRAPS

ALL WASTEWATER APPLICATIONS TO HAVE WATERTF SOIL & SEWERPIPES TO BE 1000mm GEYSERS TO BE ACCORDING TO SABS 0254

GLAZING ACCORDING TO SABA 0137 CHIMNEYS ACCORDING TO PART VV1-VV4 OF NBR

SHOWERS TO HAVE BRASS TRAPS

10 YEAR WATERPROOFING GUARENTEE TO BE CEDED TO THE CLIENT BY THE

CONTRACTOR

NO CEMENT BRICKS TO BE USED UNLESS SPECIFIED BY CLIENT, ARCHITECT OR

MASONARY, CEMENT AND CONCRETE NOTES:

ALL MASONRY UNITS TO HAVE A COMPRESSIVE STRENGTH NOT LESS THAN

7MPa.
BURNT CLAY MASONRY UNITS SHALL COMPLY WITH THE REQUIREMENTS OF SANS 227.
CONCRETE MASONRY UNITS SHALL COMPLY WITH THE REQUIREMENTS OF

SANS 1215.

MASONRY WALLING SHALL COMPLY WITH THE REQUIREMENTS OF SANS 2001-CMI: 2007

CEMENT USED FOR MORTAR SHALL BE COMMON CEMENTS COMPLYING WITH THE REQUIREMENTS OF SABS ENV 197-1 & MASONRY CEMENTS COMPLYING WITH THE REQUIREMENTS OF SABS ENV 413-1

MORTAR SHALL BE CLASS II HAVING A MIN. COMPRESSIVE STRENGTH AT 28

PRECAST CONCRETE LINTELS USED FOR STRUCTURAL PURPOSES SHALL COMPLY WITH THE REQUIREMENTS OF SANS 1504

PLY WITH THE REQUIREMENTS OF SANS 1504

NO. DESCRIPTION DATE



40 OAKTREE AVENUE
HAZELWOOD, PTA
P.O. BOX 2676
BROOKLYN SQUARE, 0075
TELEPHONE: 086 111 6222
E-MAIL: info@maaa.co.za
CC: 2000/064987/23
maaa.co.za

B.Arch(UP) SACA MIArch(SA Nr. 4972 Jannes Hattingh MArch(Prof) PrArch

Municipal Approval

Architects stamp and signature

Client signature

Other

Project Description

Huis van Niekerk

Project Address

ERF 2924
Welbedaght
Knysna

Client Name

CHARL LE ROUX VAN NIEKERK

Project Number

22314

Project Name

Huis van Niekerk

Sheet Name

SITE PLAN

Drawing Number Revision

M050


Date Scale

2023/10/13 10:24:17 As indicated

Drawn: Checked by:

K Peinke PJ Mathews

COPYRIGHT ART. 21(1) 98/1978

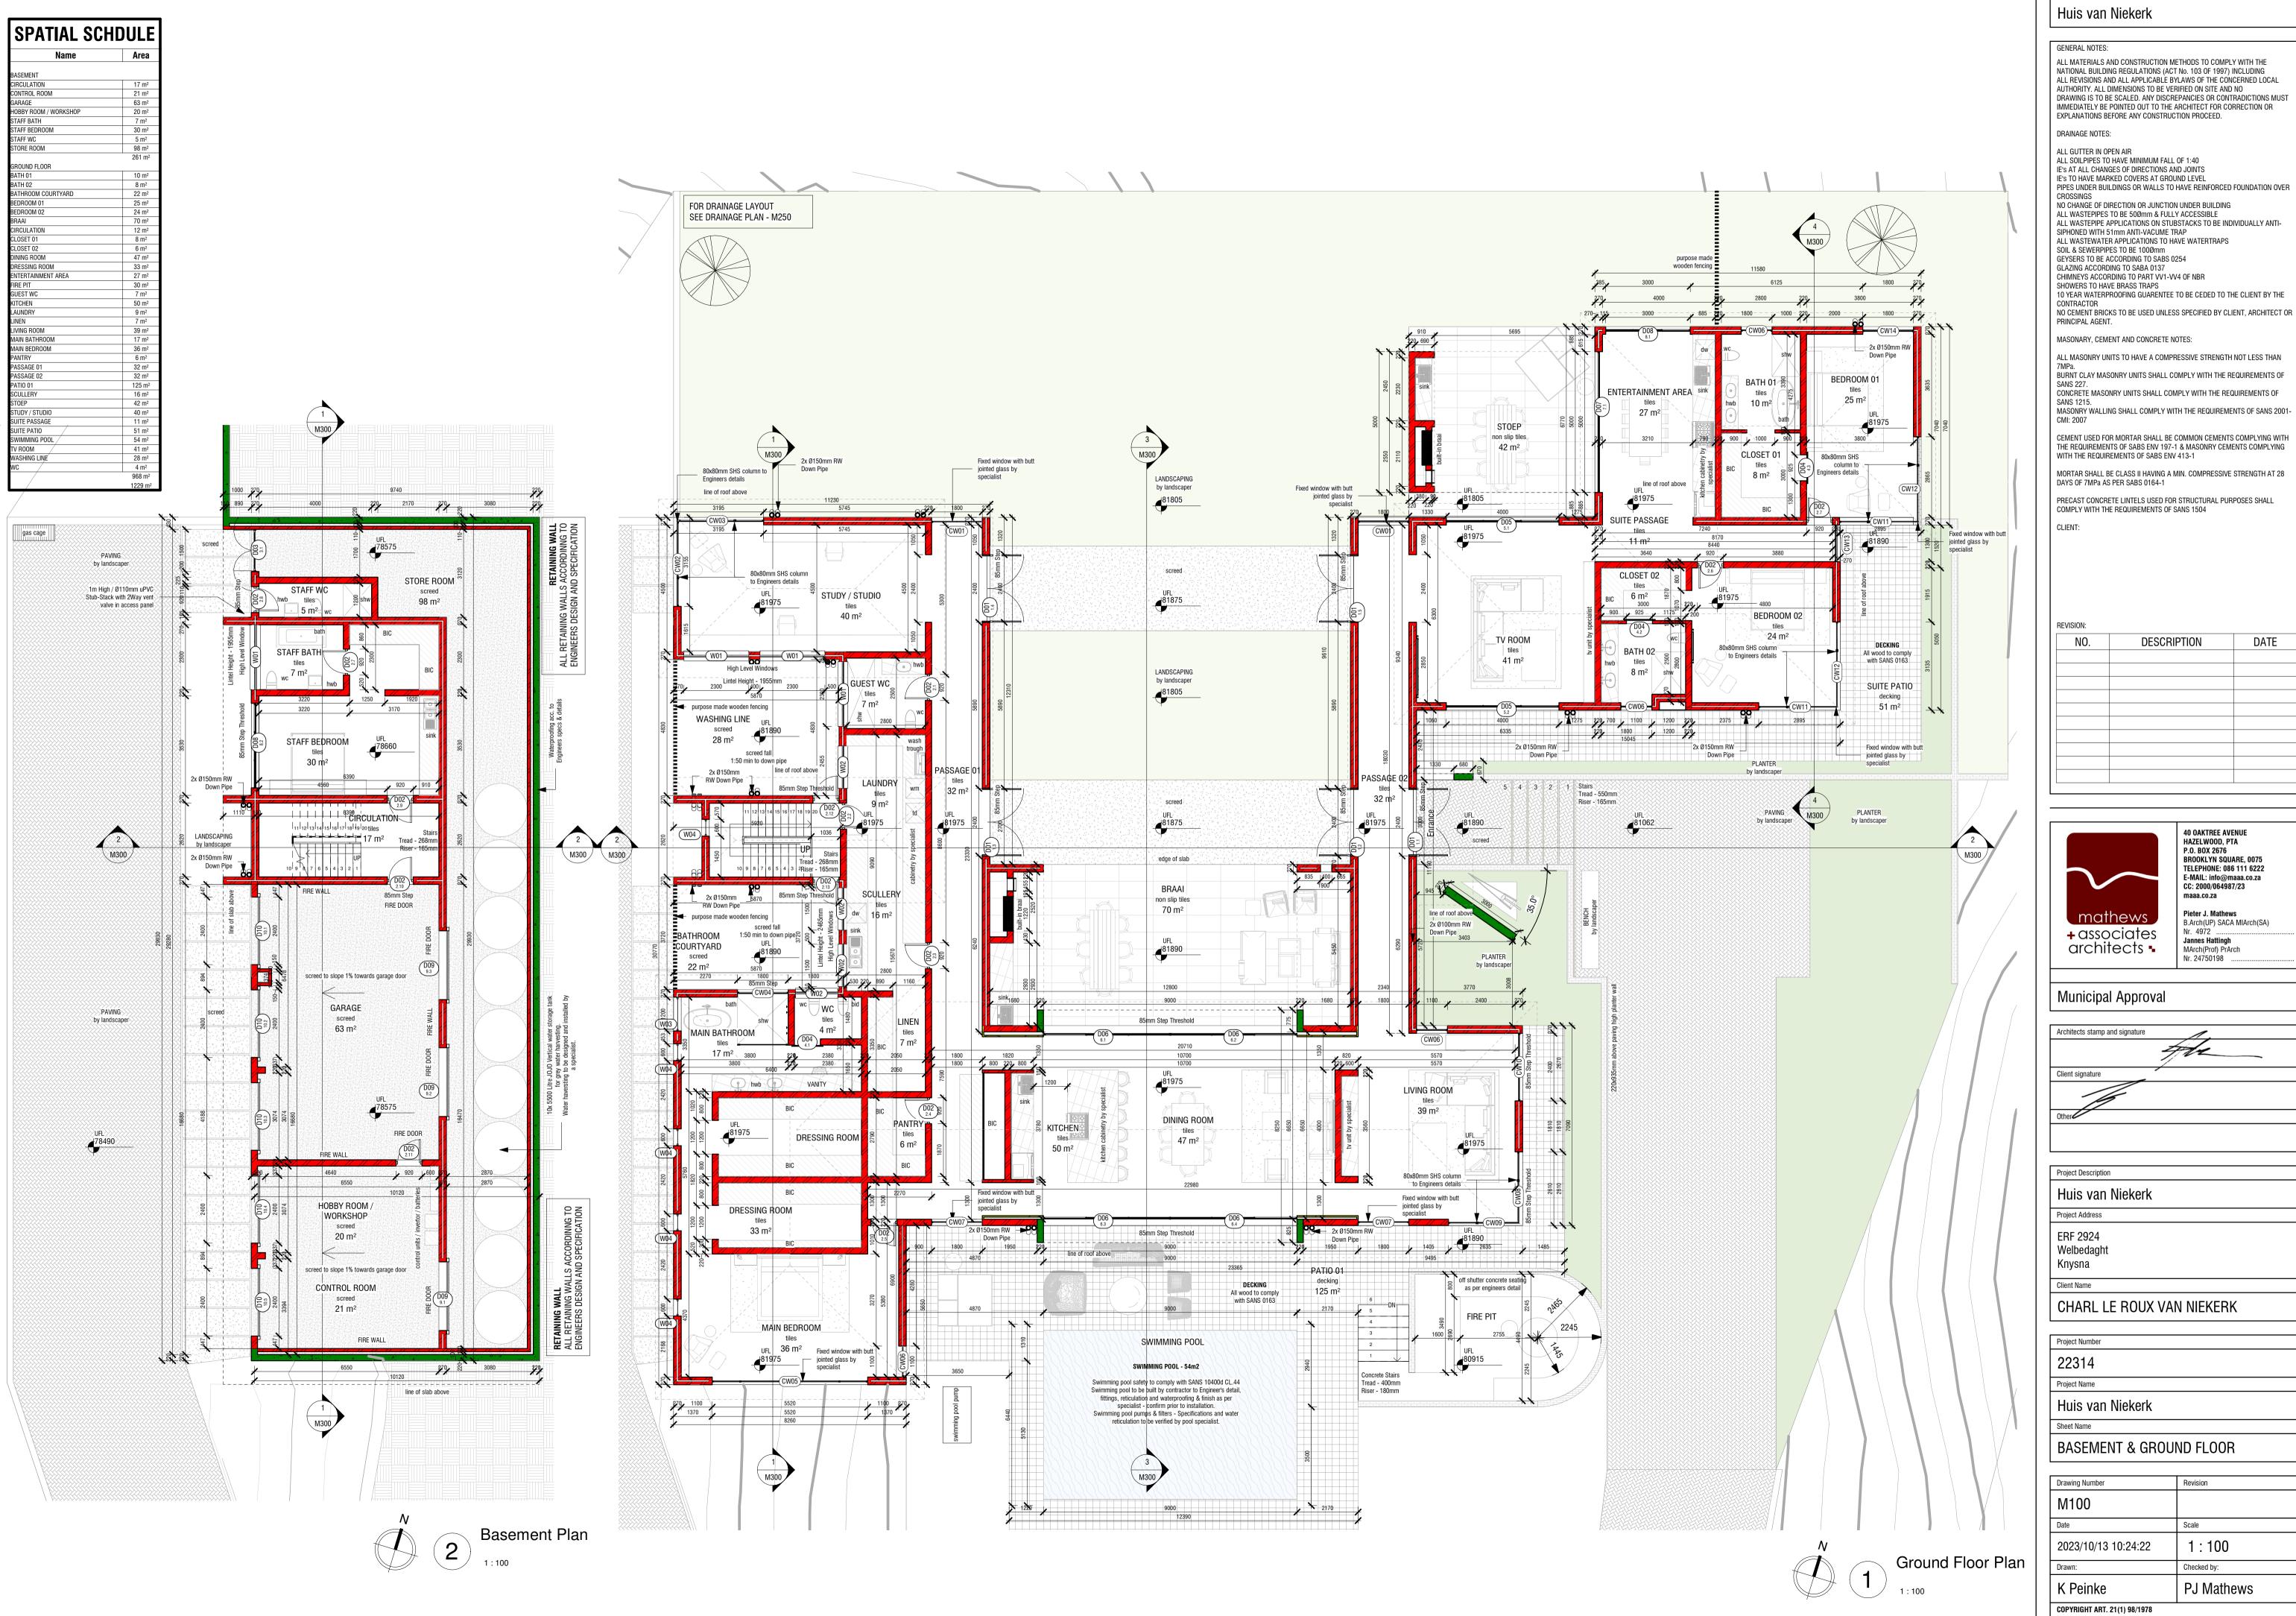

ALL MATERIALS AND CONSTRUCTION METHODS TO COMPLY WITH THE NATIONAL BUILDING REGULATIONS (ACT No. 103 OF 1997) INCLUDING ALL REVISIONS AND ALL APPLICABLE BYLAWS OF THE CONCERNED LOCAL AUTHORITY. ALL DIMENSIONS TO BE VERIFIED ON SITE AND NO DRAWING IS TO BE SCALED. ANY DISCREPANCIES OR CONTRADICTIONS MUST IMMEDIATELY BE POINTED OUT TO THE ARCHITECT FOR CORRECTION OR

IE'S TO HAVE MARKED COVERS AT GROUND LEVEL
PIPES UNDER BUILDINGS OR WALLS TO HAVE REINFORCED FOUNDATION OVER

ALL WASTEPIPES TO BE 500mm & FULLY ACCESSIBLE
ALL WASTEPIPE APPLICATIONS ON STUBSTACKS TO BE INDIVIDUALLY ANTI-

NO CEMENT BRICKS TO BE USED UNLESS SPECIFIED BY CLIENT, ARCHITECT OR


ALL MASONRY UNITS TO HAVE A COMPRESSIVE STRENGTH NOT LESS THAN

CONCRETE MASONRY UNITS SHALL COMPLY WITH THE REQUIREMENTS OF


MASONRY WALLING SHALL COMPLY WITH THE REQUIREMENTS OF SANS 2001-


PRECAST CONCRETE LINTELS USED FOR STRUCTURAL PURPOSES SHALL COMPLY WITH THE REQUIREMENTS OF SANS 1504

NO.	DESCRIPTION	DATE

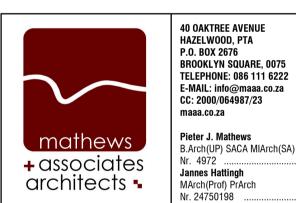

Drawing Number	Revision
M100	
Date	Scale
2023/10/13 10:24:22	1:100
Drawn:	Checked by:
K Peinke	PJ Mathews

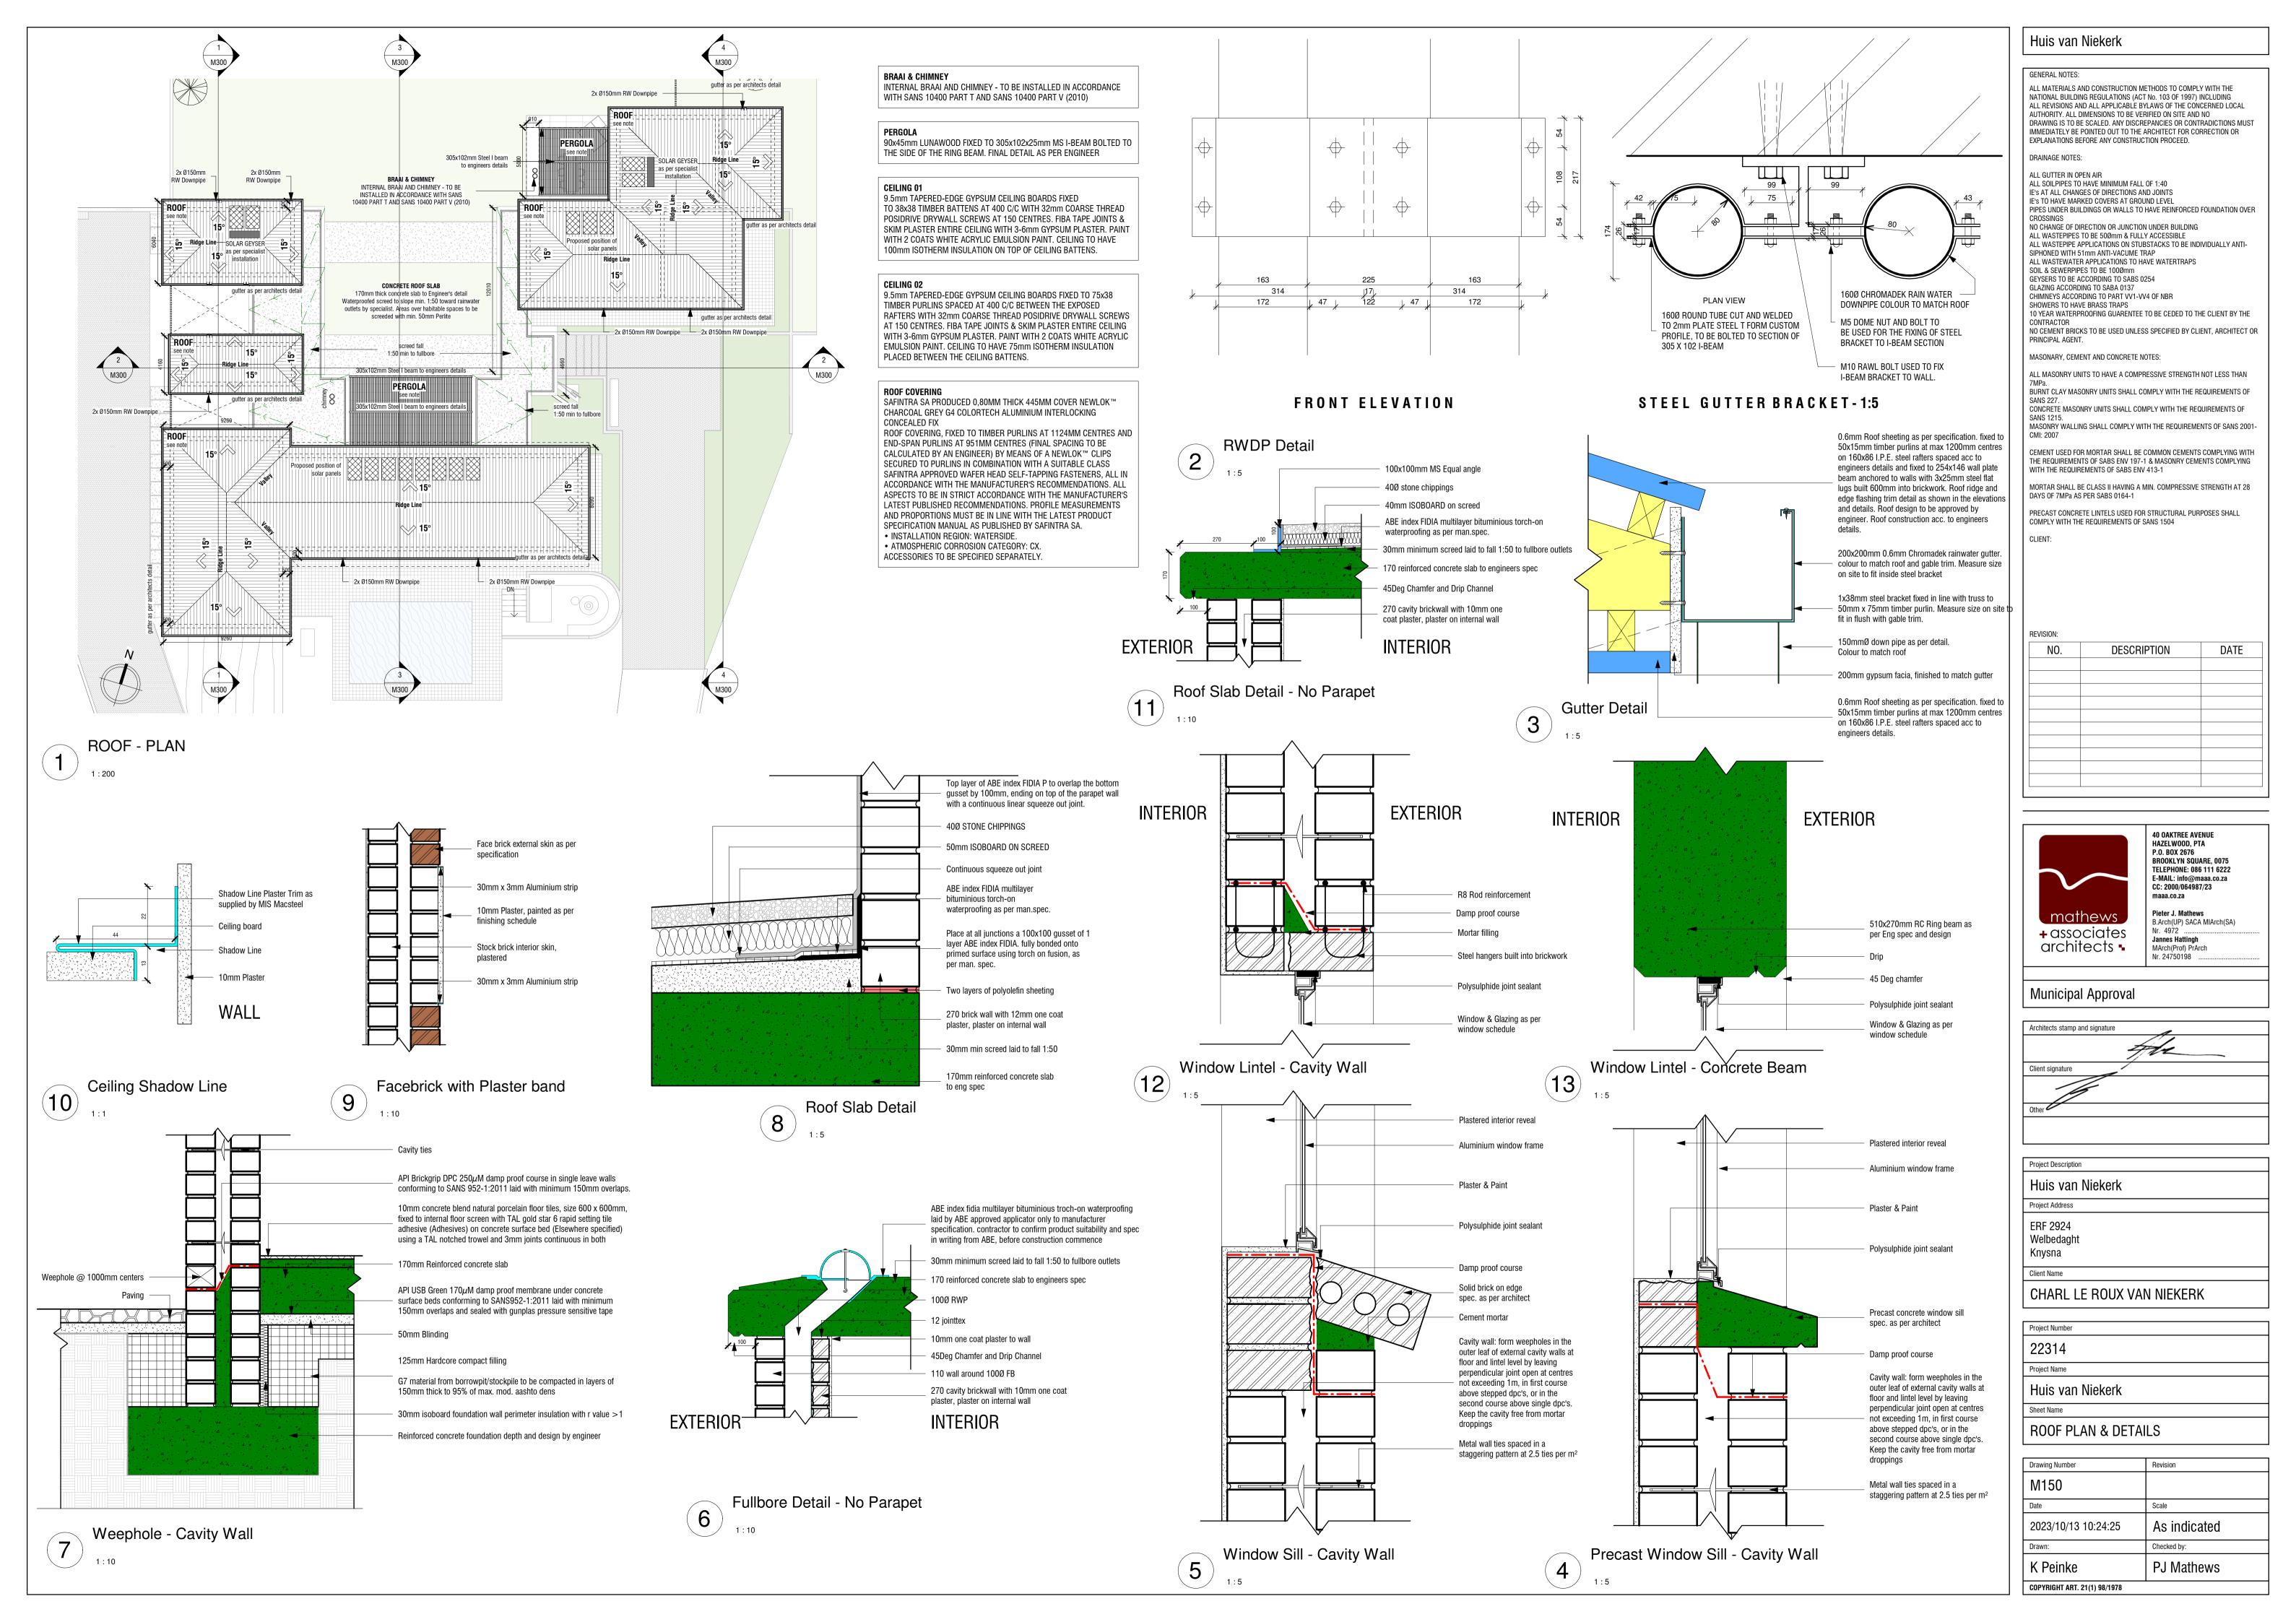

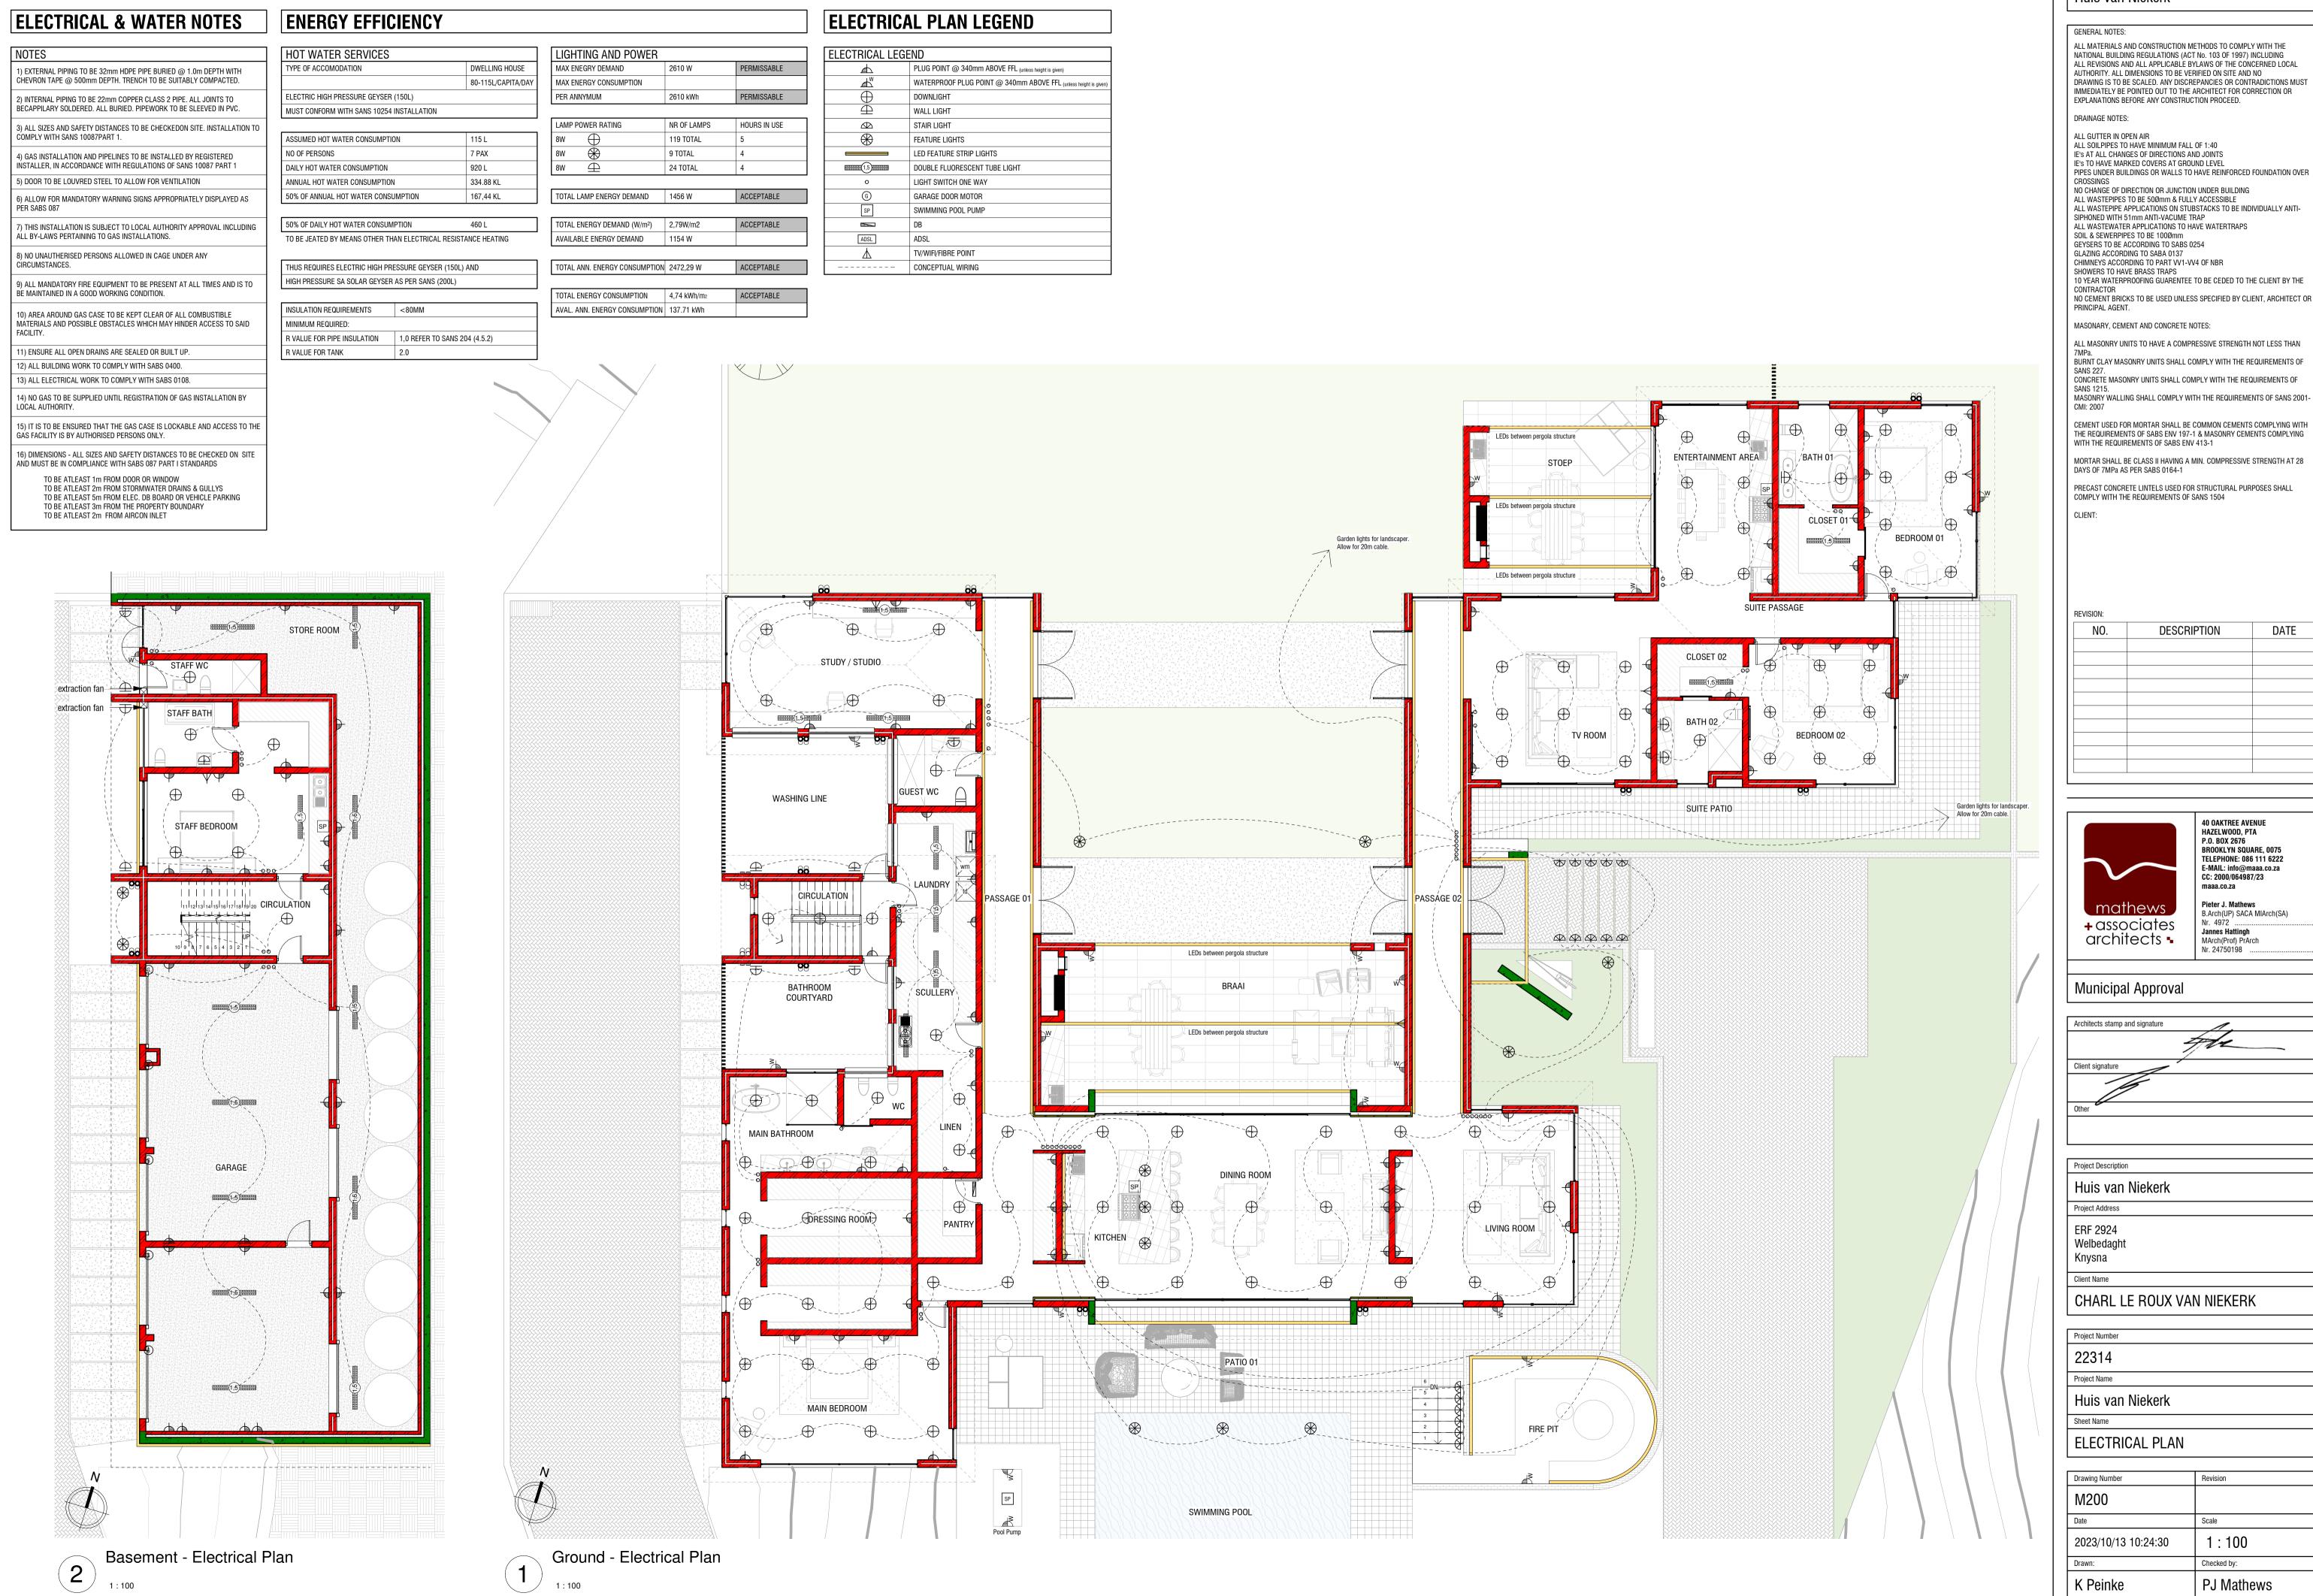

Huis van Niekerk

ALL MATERIALS AND CONSTRUCTION METHODS TO COMPLY WITH THE NATIONAL BUILDING REGULATIONS (ACT No. 103 OF 1997) INCLUDING ALL REVISIONS AND ALL APPLICABLE BYLAWS OF THE CONCERNED LOCAL AUTHORITY. ALL DIMENSIONS TO BE VERIFIED ON SITE AND NO DRAWING IS TO BE SCALED. ANY DISCREPANCIES OR CONTRADICTIONS MUST IMMEDIATELY BE POINTED OUT TO THE ARCHITECT FOR CORRECTION OR EXPLANATIONS BEFORE ANY CONSTRUCTION PROCEED.

ALL GUTTER IN OPEN AIR

ALL SOILPIPES TO HAVE MINIMUM FALL OF 1:40 IE'S AT ALL CHANGES OF DIRECTIONS AND JOINTS

NO CHANGE OF DIRECTION OR JUNCTION UNDER BUILDING ALL WASTEPIPES TO BE 500mm & FULLY ACCESSIBLE
ALL WASTEPIPE APPLICATIONS ON STUBSTACKS TO BE INDIVIDUALLY ANTI-

SIPHONED WITH 51mm ANTI-VACUME TRAP ALL WASTEWATER APPLICATIONS TO HAVE WATERTRAPS

SOIL & SEWERPIPES TO BE 1000mm GEYSERS TO BE ACCORDING TO SABS 0254 GLAZING ACCORDING TO SABA 0137 CHIMNEYS ACCORDING TO PART VV1-VV4 OF NBR

MASONARY, CEMENT AND CONCRETE NOTES:

BURNT CLAY MASONRY UNITS SHALL COMPLY WITH THE REQUIREMENTS OF CONCRETE MASONRY UNITS SHALL COMPLY WITH THE REQUIREMENTS OF

MASONRY WALLING SHALL COMPLY WITH THE REQUIREMENTS OF SANS 2001-

MORTAR SHALL BE CLASS II HAVING A MIN. COMPRESSIVE STRENGTH AT 28 DAYS OF 7MPa AS PER SABS 0164-1

PRECAST CONCRETE LINTELS USED FOR STRUCTURAL PURPOSES SHALL COMPLY WITH THE REQUIREMENTS OF SANS 1504

DESCRIPTION DATE



P.O. BOX 2676 BROOKLYN SQUARE, 0075 E-MAIL: info@maaa.co.za CC: 2000/064987/23 maaa.co.za Pieter J. Mathews B.Arch(UP) SACA MIArch(SA) Nr. 4972 ´.....

40 OAKTREE AVENUE

HAZELWOOD, PTA

Jannes Hattingh MArch(Prof) PrArch

Municipal Approval

Architects stamp and signature Client signature

Huis van Niekerk

ERF 2924 Welbedaght

CHARL LE ROUX VAN NIEKERK

Project Number


Huis van Niekerk

ELECTRICAL PLAN

Drawing Number

1:100 2023/10/13 10:24:30 Checked by: PJ Mathews

COPYRIGHT ART. 21(1) 98/1978

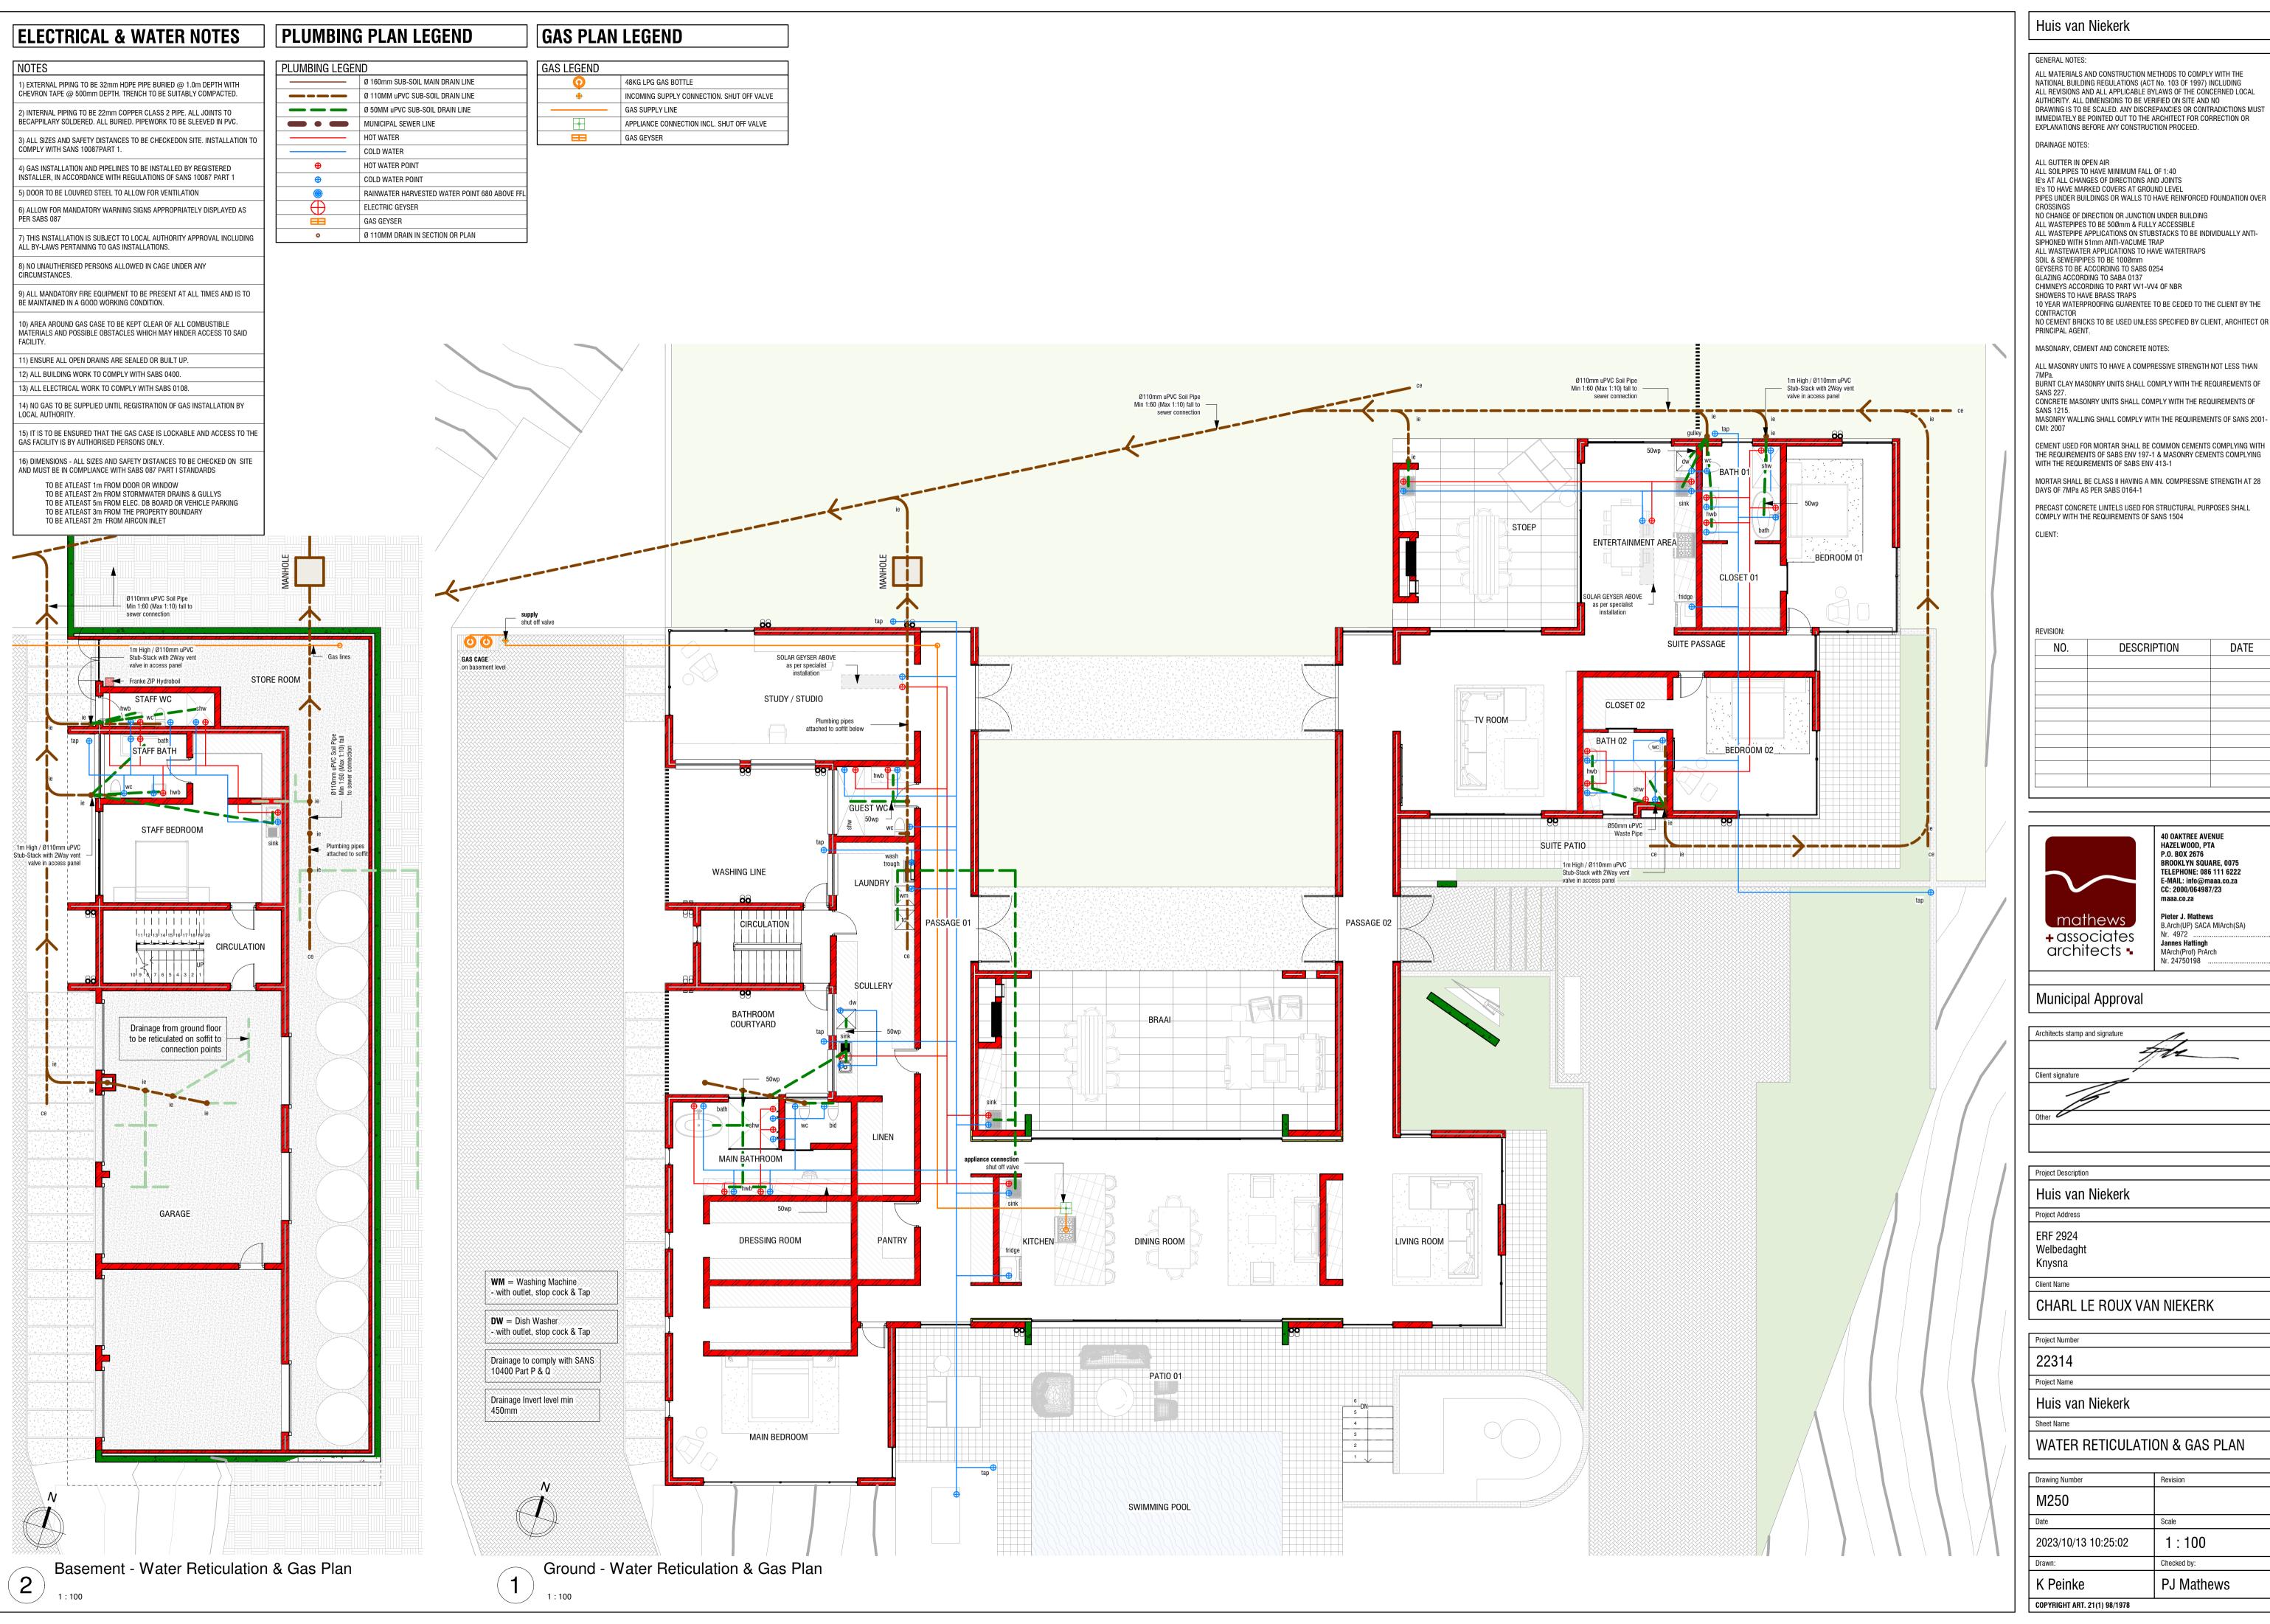

ALL MATERIALS AND CONSTRUCTION METHODS TO COMPLY WITH THE NATIONAL BUILDING REGULATIONS (ACT No. 103 OF 1997) INCLUDING ALL REVISIONS AND ALL APPLICABLE BYLAWS OF THE CONCERNED LOCAL AUTHORITY. ALL DIMENSIONS TO BE VERIFIED ON SITE AND NO DRAWING IS TO BE SCALED. ANY DISCREPANCIES OR CONTRADICTIONS MUST IMMEDIATELY BE POINTED OUT TO THE ARCHITECT FOR CORRECTION OR

PIPES UNDER BUILDINGS OR WALLS TO HAVE REINFORCED FOUNDATION OVER

ALL WASTEPIPES TO BE 500mm & FULLY ACCESSIBLE
ALL WASTEPIPE APPLICATIONS ON STUBSTACKS TO BE INDIVIDUALLY ANTI-

NO CEMENT BRICKS TO BE USED UNLESS SPECIFIED BY CLIENT, ARCHITECT OR

ALL MASONRY UNITS TO HAVE A COMPRESSIVE STRENGTH NOT LESS THAN

CONCRETE MASONRY UNITS SHALL COMPLY WITH THE REQUIREMENTS OF

MASONRY WALLING SHALL COMPLY WITH THE REQUIREMENTS OF SANS 2001-


DATE


HAZELWOOD, PTA P.O. BOX 2676 BROOKLYN SQUARE, 0075 E-MAIL: info@maaa.co.za CC: 2000/064987/23 maaa.co.za Pieter J. Mathews

B.Arch(UP) SACA MIArch(SA) Nr. 4972 ´...... Jannes Hattingh MArch(Prof) PrArch Nr. 24750198 ...


WATER RETICULATION & GAS PLAN

1:100 Checked by: PJ Mathews

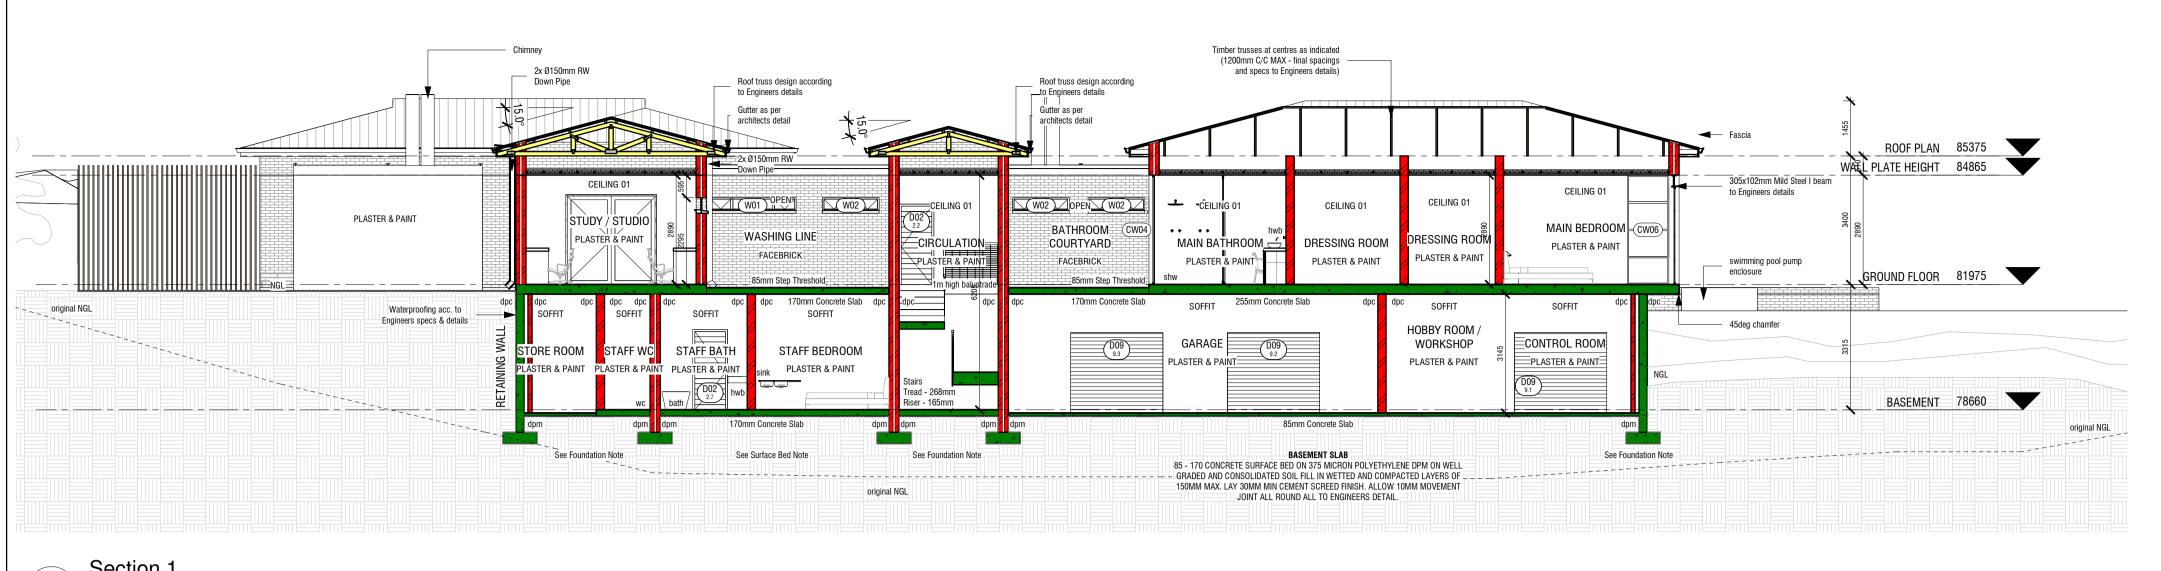

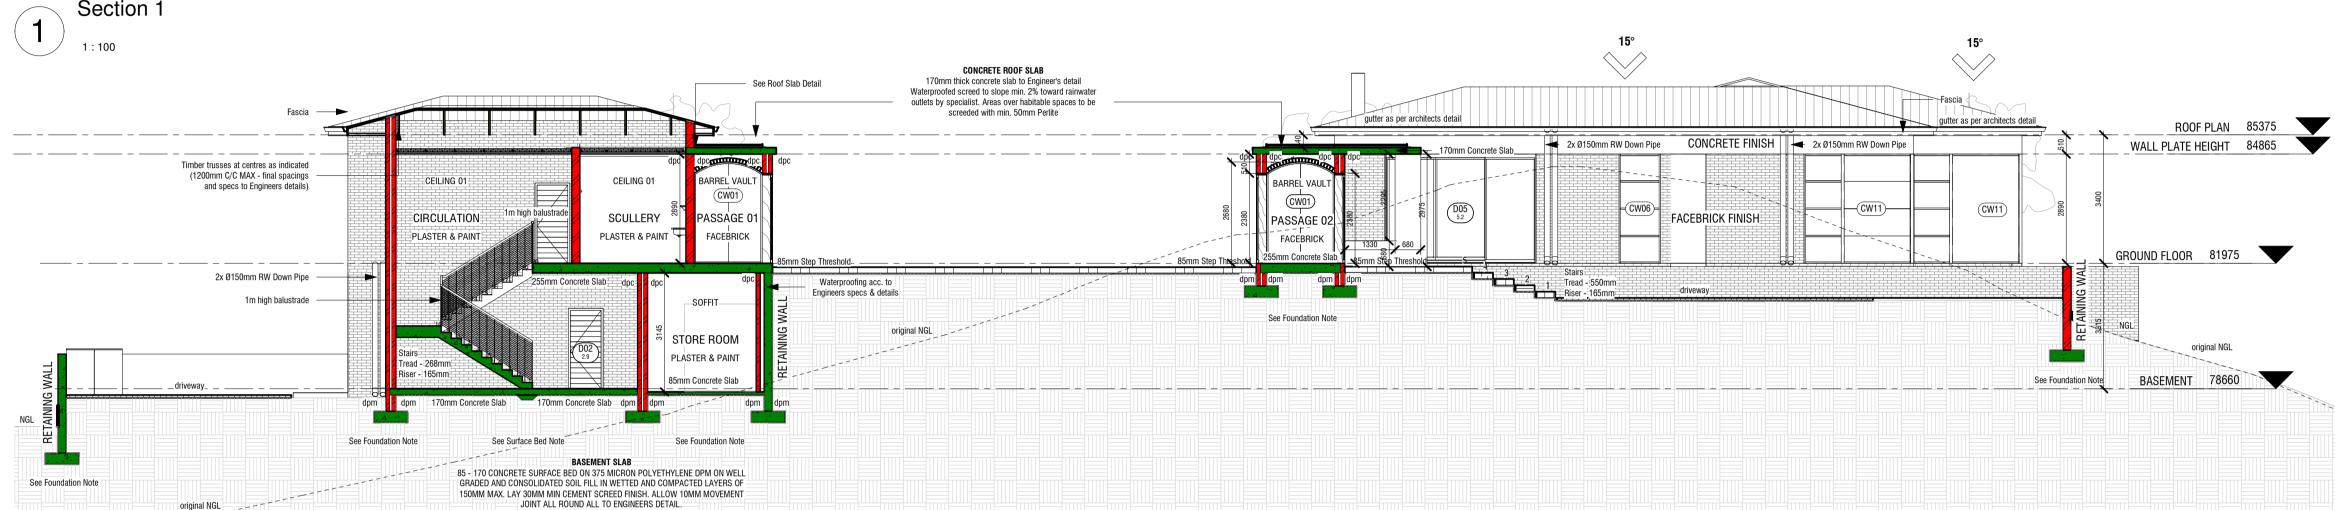

510x270mm R/C Ring beam CONCRETE ROOF SLAB to Engineers details 170mm thick concrete slab to Engineer's detail Roof truss design according Waterproofed screed to slope min. 2% toward rainwater outlets by specialist. Areas over habitable spaces to be to Engineers details screeded with min. 50mm Perlite 2x Ø150mm RW Gutter as per architects detail architects detail to engineers details WALL PLATE HEIGHT 84865 CONCRETE FINISH TIMBER PERGOLA OPEN Swimming pool safety to comply with SANS 10400d CL.44 DINING ROOM BRAAI Swimming pool to be built by contractor to Engineer's detail, PLASTER & FACEBRICK TIMBER FENCING PATIO 01 PAINT FINISH FACEBRICK FINISH PLASTER & PAINT specialist - confirm prior to installation. Swimming pool pumps & filters - Specifications and water reticulation to be verified by pool specialist.- original NGL See Surface Bed Note See Foundation Note See Foundation Note original NGL GROUND FLOOR SLAB 170 - 255 CONCRETE SURFACE BED ON 375 MICRON POLYETHYLENE DPM ON WELL GRADED AND CONSOLIDATED SOIL FILL IN WETTED AND COMPACTED LAYERS OF 150MM MAX. LAY 30MM MIN CEMENT SCREED FINISH. ALLOW 10MM MOVEMENT BASEMENT 78660 JOINT ALL ROUND ALL TO ENGINEERS DETAIL.

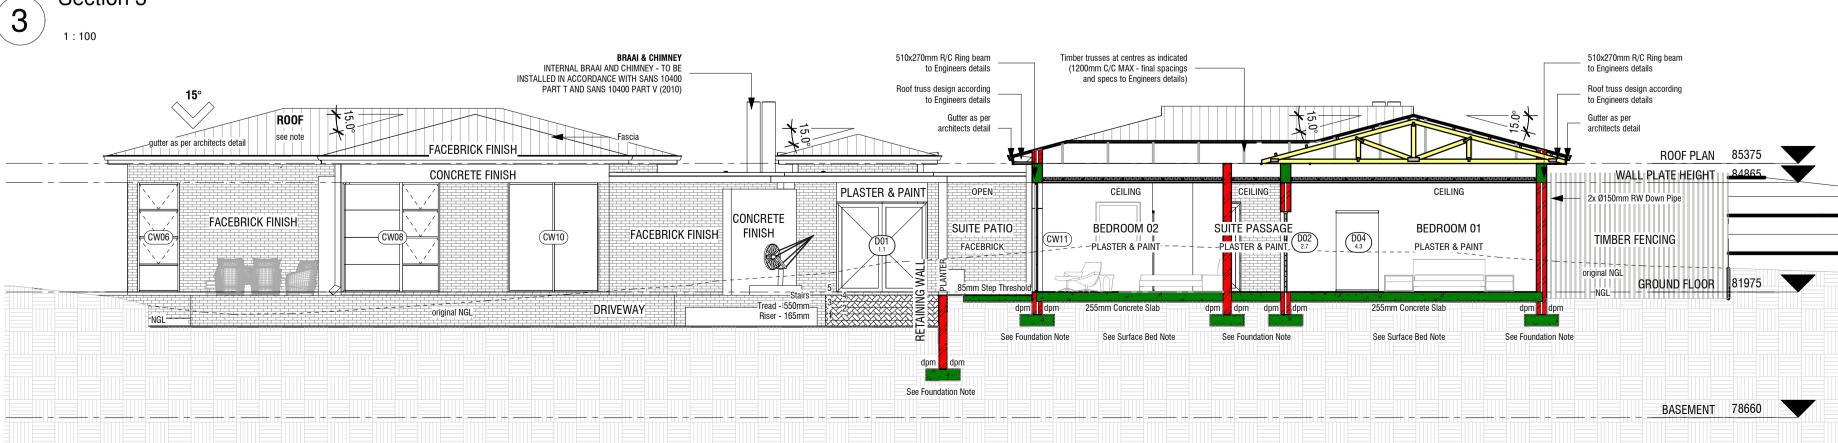

SOFFIT TO HAVE 12mm PLASTER AND PAINT. COLOUR ACC. TO OWNER

DRAINAGE

ALL SANITARY FIXINGS, COMPONENTS AND SYSTEMS, INCLUDING SEPTIC TANKS AND FRENCH DRAINS, TO COMPLY WITH THE REQUIREMENTS OF SANS 10400-P AND NON-WATER-BORNE MEANS OF SANITARY DISPOSAL TO COMPLY WITH THE REQUIREMENTS OF SANS10400-Q

GROUND FILLING

GROUND FILLING BELOW FLOORS TO COMPLY WITH THE REQUIREMENTS OF SANS 10400-J4.4.5-4.4.7

SURFACE BED

85mm CONCRETE SURFACE BED ON USB GREEN GUNDLE MEMBRANE ON FILL COMPACTED IN LAYERS OF 150mm. SURFACE BED TO COMPLY WITH THE REQUIREMENTS OF SANS 10400-J4.4

STAIRCASE ALL STAIRCASES TO COMPLY WITH THE REQUIREMENTS OF SANS 10400-M, SANS 10400-S4.9 & SANS 10400-D.

BALUSTRADE

BALUSTRADES TO BE ACC TO SAN 10400-D, SANS 10400-M, SANS 10400-T. BALUSTRADE TO BE MIN 1000mm HIGH WITH THE HANDRAIL AT MIN 850mm AND NO OPENINGS LARGER THAN 100mm. OTHERWISE THE OWNER IS TO SIGN CONSENT AND TAKE RESPONSIBILITY FOR THE SAFETY OF THE BALUSTRADE.

CAVITY WALL CAVITY WALLS TO COMPLY WITH THE REQUIREMENTS OF SANS 10400-K.

ALL RETAINING WALLS ACCORDINNG TO ENGINEERS DESIGN AND SPECIFICATION.

INTERNAL BRAAI AND CHIMNEY - TO BE INSTALLED IN ACCORDANCE

WITH SANS 10400 PART T AND SANS 10400 PART V (2010)

PERGOLA

90x45mm LUNAWOOD FIXED TO 305x102x25mm MS I-BEAM BOLTED TO THE SIDE OF THE RING BEAM. FINAL DETAIL AS PER ENGINEER

ALL GLAZING TO ADHERE TO SABS 0137 AND SANS 10400 PART N

WINDOW AND DOOR FRAMES

ALL ALUMINIUM WINDOW AND DOOR FRAMES TO BE POWDERCOATED COLOUR: RAL 7035 GREY SEE DOOR AND WINDOW SCHEDULE

CEILING 01

9.5mm TAPERED-EDGE GYPSUM CEILING BOARDS FIXED TO 38x38 TIMBER BATTENS AT 400 C/C WITH 32mm COARSE THREAD POSIDRIVE DRYWALL SCREWS AT 150 CENTRES. FIBA TAPE JOINTS & SKIM PLASTER ENTIRE CEILING WITH 3-6mm GYPSUM PLASTER. PAINT WITH 2 COATS WHITE ACRYLIC EMULSION PAINT, CEILING TO HAVE 100mm ISOTHERM INSULATION ON TOP OF CEILING BATTENS.

ROOF COVERING

SAFINTRA SA PRODUCED 0,80MM THICK 445MM COVER NEWLOK™ CHARCOAL GREY G4 COLORTECH ALUMINIUM INTERLOCKING CONCEALED FIX

ROOF COVERING, FIXED TO TIMBER PURLINS AT 1124MM CENTRES AND END-SPAN PURLINS AT 951MM CENTRES (FINAL SPACING TO BE CALCULATED BY AN ENGINEER) BY MEANS OF A NEWLOK™ CLIPS SECURED TO PURLINS IN COMBINATION WITH A SUITABLE CLASS SAFINTRA APPROVED WAFER HEAD SELF-TAPPING FASTENERS, ALL IN ACCORDANCE WITH THE MANUFACTURER'S RECOMMENDATIONS. ALL ASPECTS TO BE IN STRICT ACCORDANCE WITH THE MANUFACTURER'S LATEST PUBLISHED RECOMMENDATIONS. PROFILE MEASUREMENTS AND PROPORTIONS MUST BE IN LINE WITH THE LATEST PRODUCT SPECIFICATION MANUAL AS PUBLISHED BY SAFINTRA SA.

• INSTALLATION REGION: WATERSIDE. • ATMOSPHERIC CORROSION CATEGORY: CX. ACCESSORIES TO BE SPECIFIED SEPARATELY.

FOUNDATION

ALL FOUNDATIONS TO BE ACCORDING TO ENGINEER'S DESIGN AND SPECIFICATIONS. ALL SUCH FOUNDATIONS TO COMPLY WITH SANS10400-B, SANS 10400-G AND SANS 10400-H

RAFT FOUNDATION

RAFT FOUNDATION STRICTLY ACCORDING TO ENGINEER'S SPEC. AND TO COMPLY WITH THE REQUIREMENTS OF SANS 10400-B, SANS 10400-G AND SANS 10400-H.

Huis van Niekerk

GENERAL NOTES:

ALL MATERIALS AND CONSTRUCTION METHODS TO COMPLY WITH THE NATIONAL BUILDING REGULATIONS (ACT No. 103 OF 1997) INCLUDING ALL REVISIONS AND ALL APPLICABLE BYLAWS OF THE CONCERNED LOCAL AUTHORITY. ALL DIMENSIONS TO BE VERIFIED ON SITE AND NO DRAWING IS TO BE SCALED. ANY DISCREPANCIES OR CONTRADICTIONS MUST IMMEDIATELY BE POINTED OUT TO THE ARCHITECT FOR CORRECTION OR EXPLANATIONS BEFORE ANY CONSTRUCTION PROCEED.

DRAINAGE NOTES:

PRINCIPAL AGENT.

ALL GUTTER IN OPEN AIR ALL SOILPIPES TO HAVE MINIMUM FALL OF 1:40 IE'S AT ALL CHANGES OF DIRECTIONS AND JOINTS IE'S TO HAVE MARKED COVERS AT GROUND LEVEL PIPES UNDER BUILDINGS OR WALLS TO HAVE REINFORCED FOUNDATION OVER

NO CHANGE OF DIRECTION OR JUNCTION UNDER BUILDING ALL WASTEPIPES TO BE 500mm & FULLY ACCESSIBLE
ALL WASTEPIPE APPLICATIONS ON STUBSTACKS TO BE INDIVIDUALLY ANTI-SIPHONED WITH 51mm ANTI-VACUME TRAP

ALL WASTEWATER APPLICATIONS TO HAVE WATERTRAPS SOIL & SEWERPIPES TO BE 1000mm GEYSERS TO BE ACCORDING TO SABS 0254 GLAZING ACCORDING TO SABA 0137 CHIMNEYS ACCORDING TO PART VV1-VV4 OF NBR

SHOWERS TO HAVE BRASS TRAPS 10 YEAR WATERPROOFING GUARENTEE TO BE CEDED TO THE CLIENT BY THE CONTRACTOR NO CEMENT BRICKS TO BE USED UNLESS SPECIFIED BY CLIENT, ARCHITECT OR

MASONARY, CEMENT AND CONCRETE NOTES:

DAYS OF 7MPa AS PER SABS 0164-1

CLIENT:

ALL MASONRY UNITS TO HAVE A COMPRESSIVE STRENGTH NOT LESS THAN


BURNT CLAY MASONRY UNITS SHALL COMPLY WITH THE REQUIREMENTS OF SANS 227 CONCRETE MASONRY UNITS SHALL COMPLY WITH THE REQUIREMENTS OF SANS 1215.

MASONRY WALLING SHALL COMPLY WITH THE REQUIREMENTS OF SANS 2001-CMI: 2007 CEMENT USED FOR MORTAR SHALL BE COMMON CEMENTS COMPLYING WITH THE REQUIREMENTS OF SABS ENV 197-1 & MASONRY CEMENTS COMPLYING

WITH THE REQUIREMENTS OF SABS ENV 413-1 MORTAR SHALL BE CLASS II HAVING A MIN. COMPRESSIVE STRENGTH AT 28

PRECAST CONCRETE LINTELS USED FOR STRUCTURAL PURPOSES SHALL COMPLY WITH THE REQUIREMENTS OF SANS 1504

REVISION: DESCRIPTION DATE

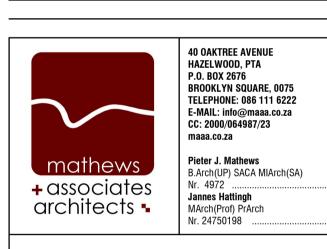



Architects stamp and signature Client signature

Project Description			
Huis van N	iekerk		
Project Address			
ERF 2924			
Welbedaght			
Knysna			
Client Name			
CHARL LE	ROUX VAI	NIEKERK	

Project Number

K Peinke


COPYRIGHT ART. 21(1) 98/1978

22314


Project Name	
Huis van Niekerk	
Sheet Name	
SECTIONS	
Drawing Number	Revision
M300	
Date	Scale
2023/10/13 10:25:21	1:100
Drawn:	Checked by:

PJ Mathews


Section 4

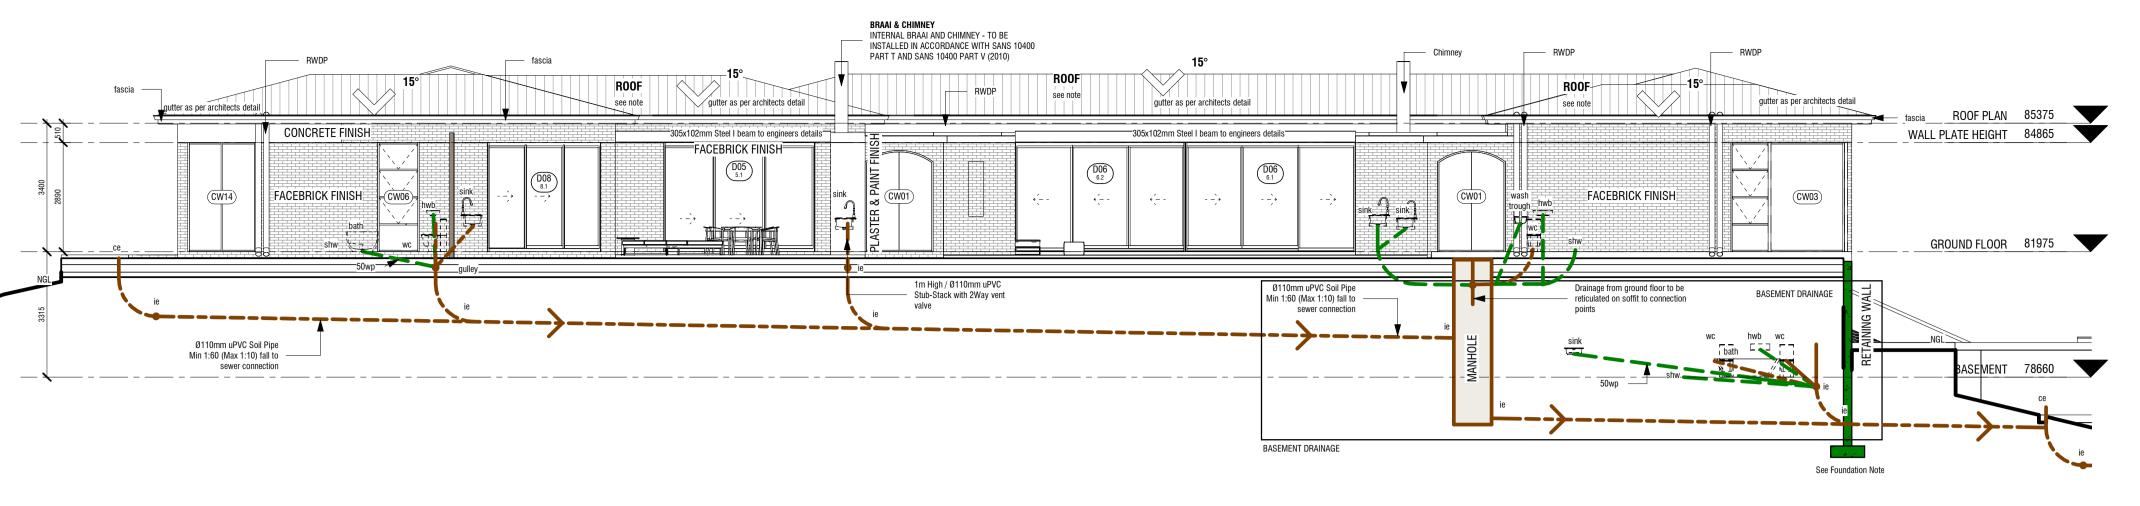


NORTH ELEVATION

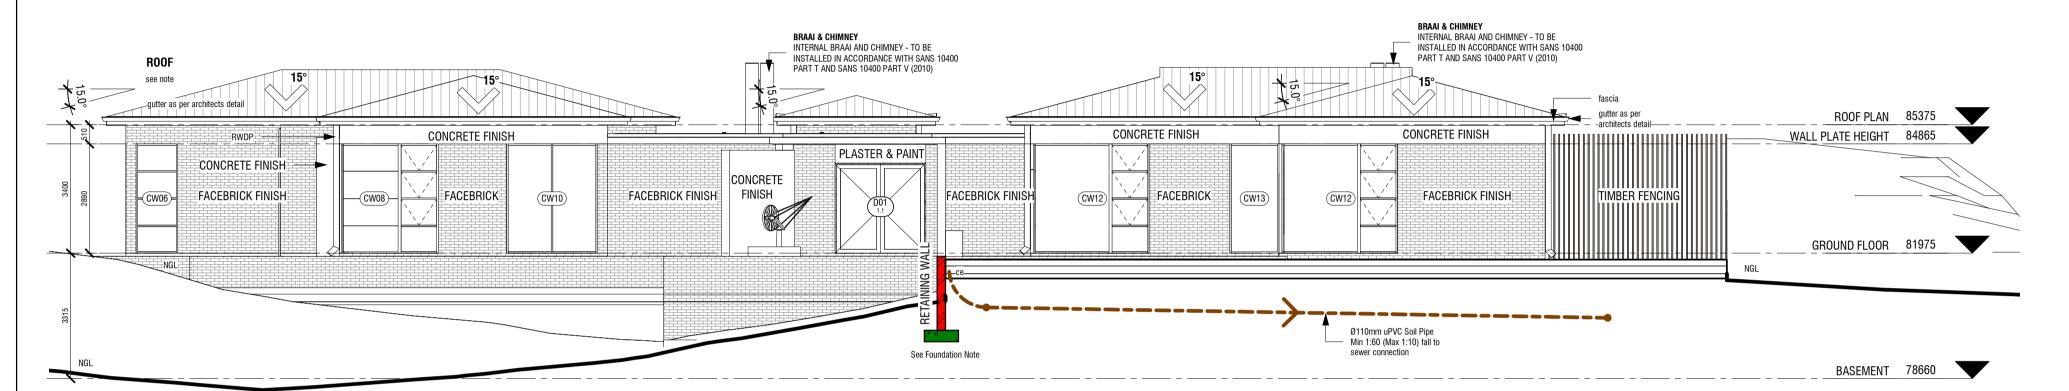

EAST ELEVATION

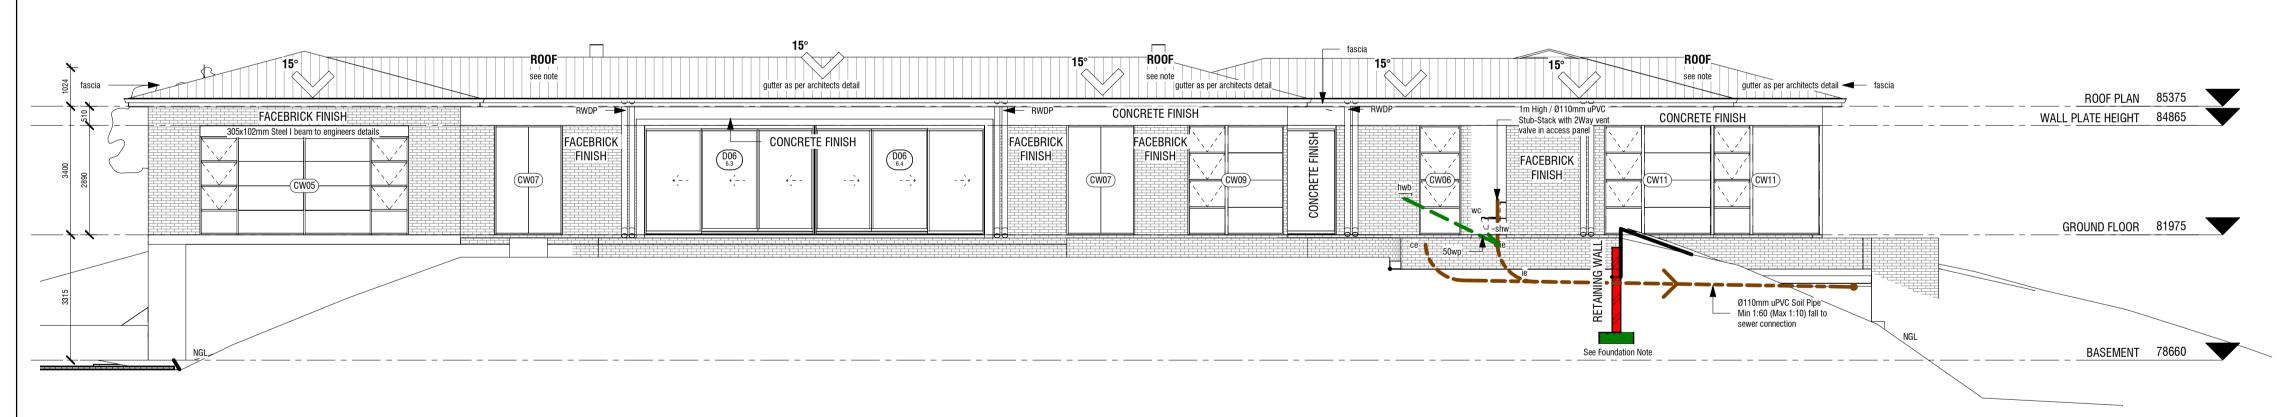

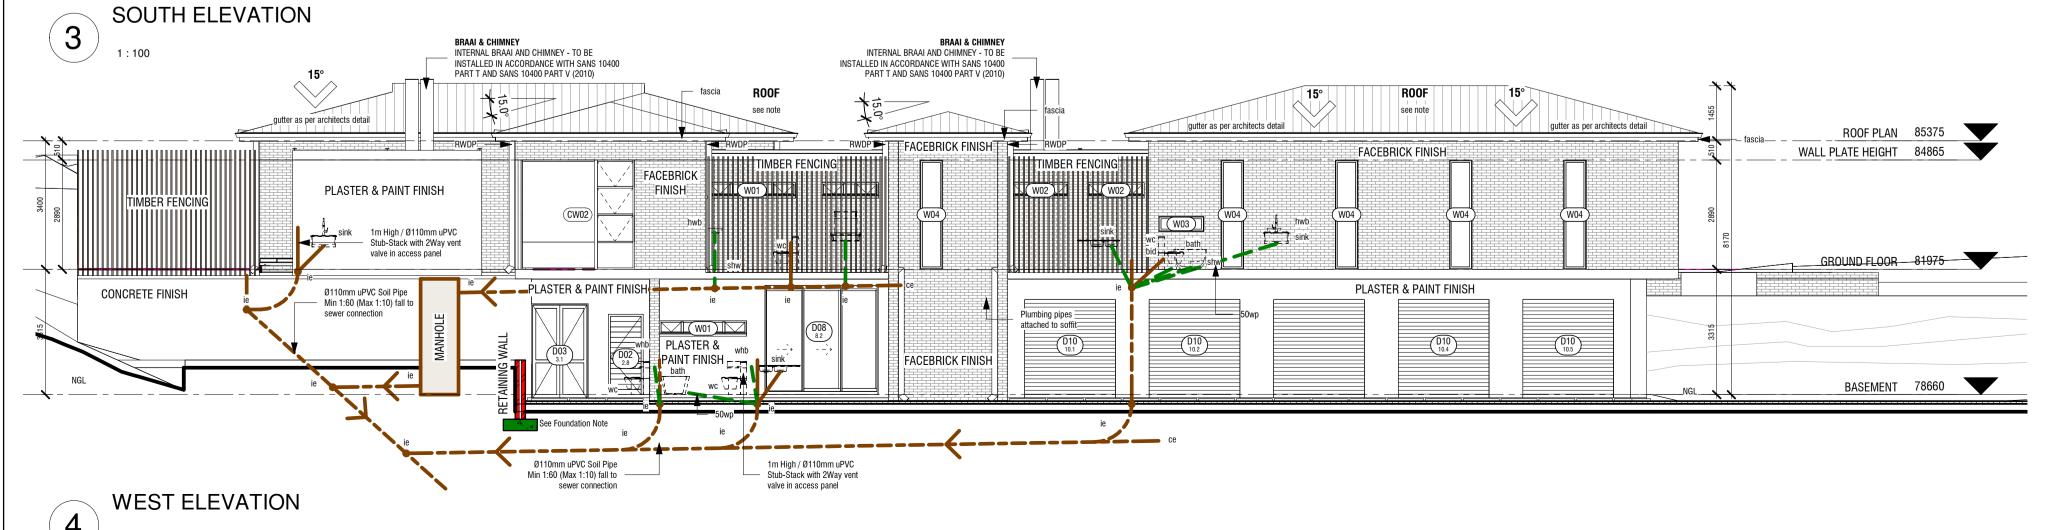

SOFFIT TO HAVE 12mm PLASTER AND PAINT. COLOUR ACC. TO OWNER

DRAINAGE

ALL SANITARY FIXINGS, COMPONENTS AND SYSTEMS, INCLUDING SEPTIC TANKS AND FRENCH DRAINS, TO COMPLY WITH THE REQUIREMENTS OF SANS 10400-P AND NON-WATER-BORNE MEANS OF SANITARY DISPOSAL TO COMPLY WITH THE REQUIREMENTS OF SANS10400-Q

GROUND FILLING

GROUND FILLING BELOW FLOORS TO COMPLY WITH THE REQUIREMENTS OF SANS 10400-J4.4.5-4.4.7

SURFACE BED

85mm CONCRETE SURFACE BED ON USB GREEN GUNDLE MEMBRANE ON FILL COMPACTED IN LAYERS OF 150mm. SURFACE BED TO COMPLY WITH THE REQUIREMENTS OF SANS 10400-J4.4

STAIRCASE ALL STAIRCASES TO COMPLY WITH THE REQUIREMENTS OF SANS 10400-M, SANS 10400-S4.9 & SANS 10400-D.

BALUSTRADE

SANS 10400-K.

BALUSTRADES TO BE ACC TO SAN 10400-D, SANS 10400-M, SANS 10400-T. BALUSTRADE TO BE MIN 1000mm HIGH WITH THE HANDRAIL AT MIN 850mm AND NO OPENINGS LARGER THAN 100mm. OTHERWISE THE OWNER IS TO SIGN CONSENT AND TAKE RESPONSIBILITY FOR THE SAFETY OF THE BALUSTRADE.

CAVITY WALL CAVITY WALLS TO COMPLY WITH THE REQUIREMENTS OF

RETAINING WALL

ALL RETAINING WALLS ACCORDINNG TO ENGINEERS DESIGN AND SPECIFICATION.

BRAAI & CHIMNEY

INTERNAL BRAAI AND CHIMNEY - TO BE INSTALLED IN ACCORDANCE WITH SANS 10400 PART T AND SANS 10400 PART V (2010)

PERGOLA

90x45mm LUNAWOOD FIXED TO 305x102x25mm MS I-BEAM BOLTED TO THE SIDE OF THE RING BEAM. FINAL DETAIL AS PER ENGINEER

GLAZING

ALL GLAZING TO ADHERE TO SABS 0137 AND SANS 10400 PART N

WINDOW AND DOOR FRAMES

ALL ALUMINIUM WINDOW AND DOOR FRAMES TO BE POWDERCOATED COLOUR: RAL 7035 GREY SEE DOOR AND WINDOW SCHEDULE

CEILING 01 9.5mm Tapered-edge Gypsum Ceiling Boards fixed TO 38x38 TIMBER BATTENS AT 400 C/C WITH 32mm COARSE THREAD POSIDRIVE DRYWALL SCREWS AT 150 CENTRES. FIBA TAPE JOINTS & SKIM PLASTER ENTIRE CEILING WITH 3-6mm GYPSUM PLASTER. PAINT WITH 2 COATS WHITE ACRYLIC EMULSION PAINT, CEILING TO HAVE 100mm ISOTHERM INSULATION ON TOP OF CEILING BATTENS.

CEILING 02

9.5mm TAPERED-EDGE GYPSUM CEILING BOARDS FIXED TO 75x38 TIMBER PURLINS SPACED AT 400 C/C BETWEEN THE EXPOSED RAFTERS WITH 32mm COARSE THREAD POSIDRIVE DRYWALL SCREWS AT 150 CENTRES. FIBA TAPE JOINTS & SKIM PLASTER ENTIRE CEILING WITH 3-6mm GYPSUM PLASTER. PAINT WITH 2 COATS WHITE ACRYLIC EMULSION PAINT. CEILING TO HAVE 75mm ISOTHERM INSULATION PLACED BETWEEN THE CEILING BATTENS.

ROOF COVERING

SAFINTRA SA PRODUCED 0,80MM THICK 445MM COVER NEWLOK™ CHARCOAL GREY G4 COLORTECH ALUMINIUM INTERLOCKING CONCEALED FIX ROOF COVERING, FIXED TO TIMBER PURLINS AT 1124MM CENTRES AND END-SPAN PURLINS AT 951MM CENTRES (FINAL SPACING TO BE CALCULATED BY AN ENGINEER) BY MEANS OF A NEWLOK™ CLIPS SECURED TO PURLINS IN COMBINATION WITH A SUITABLE CLASS

SAFINTRA APPROVED WAFER HEAD SELF-TAPPING FASTENERS, ALL IN ACCORDANCE WITH THE MANUFACTURER'S RECOMMENDATIONS. ALL ASPECTS TO BE IN STRICT ACCORDANCE WITH THE MANUFACTURER'S LATEST PUBLISHED RECOMMENDATIONS. PROFILE MEASUREMENTS AND PROPORTIONS MUST BE IN LINE WITH THE LATEST PRODUCT SPECIFICATION MANUAL AS PUBLISHED BY SAFINTRA SA. • INSTALLATION REGION: WATERSIDE.

• ATMOSPHERIC CORROSION CATEGORY: CX. ACCESSORIES TO BE SPECIFIED SEPARATELY.

FOUNDATION

ALL FOUNDATIONS TO BE ACCORDING TO ENGINEER'S DESIGN AND SPECIFICATIONS. ALL SUCH FOUNDATIONS TO COMPLY WITH SANS10400-B, SANS 10400-G AND SANS 10400-H

RAFT FOUNDATION

RAFT FOUNDATION STRICTLY ACCORDING TO ENGINEER'S SPEC. AND TO COMPLY WITH THE REQUIREMENTS OF SANS 10400-B, SANS 10400-G AND SANS 10400-H.

Huis van Niekerk

GENERAL NOTES:

ALL MATERIALS AND CONSTRUCTION METHODS TO COMPLY WITH THE NATIONAL BUILDING REGULATIONS (ACT No. 103 OF 1997) INCLUDING ALL REVISIONS AND ALL APPLICABLE BYLAWS OF THE CONCERNED LOCAL ALITHORITY ALL DIMENSIONS TO BE VERIFIED ON SITE AND NO DRAWING IS TO BE SCALED. ANY DISCREPANCIES OR CONTRADICTIONS MUST IMMEDIATELY BE POINTED OUT TO THE ARCHITECT FOR CORRECTION OR EXPLANATIONS BEFORE ANY CONSTRUCTION PROCEED.

DRAINAGE NOTES:

CONTRACTOR

PRINCIPAL AGENT.

ALL GUTTER IN OPEN AIR ALL SOILPIPES TO HAVE MINIMUM FALL OF 1:40 IE'S AT ALL CHANGES OF DIRECTIONS AND JOINTS IE'S TO HAVE MARKED COVERS AT GROUND LEVEL

NO CHANGE OF DIRECTION OR JUNCTION UNDER BUILDING

PIPES UNDER BUILDINGS OR WALLS TO HAVE REINFORCED FOUNDATION OVER

ALL WASTEPIPES TO BE 500mm & FULLY ACCESSIBLE ALL WASTEPIPE APPLICATIONS ON STUBSTACKS TO BE INDIVIDUALLY ANTI-SIPHONED WITH 51mm ANTI-VACUME TRAP

ALL WASTEWATER APPLICATIONS TO HAVE WATERTRAPS SOIL & SEWERPIPES TO BE 1000mm GEYSERS TO BE ACCORDING TO SABS 0254

GLAZING ACCORDING TO SABA 0137 CHIMNEYS ACCORDING TO PART VV1-VV4 OF NBR SHOWERS TO HAVE BRASS TRAPS 10 YEAR WATERPROOFING GUARENTEE TO BE CEDED TO THE CLIENT BY THE

MASONARY, CEMENT AND CONCRETE NOTES:

ALL MASONRY UNITS TO HAVE A COMPRESSIVE STRENGTH NOT LESS THAN BURNT CLAY MASONRY UNITS SHALL COMPLY WITH THE REQUIREMENTS OF

NO CEMENT BRICKS TO BE USED UNLESS SPECIFIED BY CLIENT, ARCHITECT OR

SANS 227. CONCRETE MASONRY UNITS SHALL COMPLY WITH THE REQUIREMENTS OF SANS 1215. MASONRY WALLING SHALL COMPLY WITH THE REQUIREMENTS OF SANS 2001-

CMI: 2007 CEMENT USED FOR MORTAR SHALL BE COMMON CEMENTS COMPLYING WITH THE REQUIREMENTS OF SABS ENV 197-1 & MASONRY CEMENTS COMPLYING

WITH THE REQUIREMENTS OF SABS ENV 413-1 MORTAR SHALL BE CLASS II HAVING A MIN. COMPRESSIVE STRENGTH AT 28


DAYS OF 7MPa AS PER SABS 0164-1 PRECAST CONCRETE LINTELS USED FOR STRUCTURAL PURPOSES SHALL

CLIENT:

REVISION:

COMPLY WITH THE REQUIREMENTS OF SANS 1504

DESCRIPTION DATE

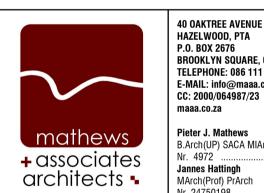

BROOKLYN SQUARE, 0075 TELEPHONE: 086 111 6222 E-MAIL: info@maaa.co.za CC: 2000/064987/23 maaa.co.za Pieter J. Mathews B.Arch(UP) SACA MIArch(SA)

Nr. 4972 ´...... Jannes Hattingh MArch(Prof) PrArch Nr. 247̇5019́8 ..

Municipal Approval

Architects stamp and signature Client signature

Huis van Niekerk

Project Address ERF 2924 Welbedaght

Knysna Client Name

CHARL LE ROUX VAN NIEKERK

Project Number 22314 Project Name Huis van Niekerk Sheet Name

ELEVATIONS

COPYRIGHT ART. 21(1) 98/1978

Drawing Number M400 Scale 1:100 2023/10/13 10:25:24 Checked by: K Peinke PJ Mathews

Project Description



W17 W,NW,N,NE,E W21 W,NW,N,NE,E

D5 SW,S,SE

SW,S,SE SW,S,SE

SW,S,SE SW,S,SE SW,S,SE

SW,S,SE

SW,S,SE

SW,S,SE

Fenestration %: IF >20%, use this to enter Table 4

Storey net internal **floor area** b /f 735,52

W,NW,N,NE,E W,NW,N,NE,E W,NW,N,NE,E

Total W,NW,N,NE,E orientated fenest'n area

n/a n/a n/a n/a

5 3,91 n/a n/a n/a n/a n/a

0,51 n/a n/a n/a n/a

0,00 n/a n/a n/a n/a n/a **3,80**

 0,00
 n/a
 n/a
 n/a
 n/a
 3,80

 0,00
 n/a
 n/a
 n/a
 n/a
 3,80

1 5,20 n/a n/a n/a n/a n/a

Divide by W,NW,N,NE,E area sub-total 104,27

FOR DISCUSSION ONLY PRELIMINARY DOOR SCHEDULE

DOOR COUNT

ALL GLASS. COMPLYING WITH SANS 1263 PART 1, 2 OR 3 WITH NAME OF THE MANUFACTURER PERMANENTLY MARKED ON EACH PANE VISIBLE AFTER GLAZING, IN ACCORDANCE WITH NBR PART N SCHEDULE 1 AND SANS 10137:2002

GENERAL NOTES: ALL MATERIALS AND CONSTRUCTION METHODS TO COMPLY WITH THE NATIONAL BUILDING REGULATIONS (ACT No. 103 OF 1997) INCLUDING ALL REVISIONS AND ALL APPLICABLE BYLAWS OF THE CONCERNED LOCAL

DRAWING IS TO BE SCALED. ANY DISCREPANCIES OR CONTRADICTIONS MUST IMMEDIATELY BE POINTED OUT TO THE ARCHITECT FOR CORRECTION OR EXPLANATIONS BEFORE ANY CONSTRUCTION PROCEED.

DRAINAGE NOTES:

Huis van Niekerk

ALL GUTTER IN OPEN AIR ALL SOILPIPES TO HAVE MINIMUM FALL OF 1:40

AUTHORITY, ALL DIMENSIONS TO BE VERIFIED ON SITE AND NO

IE'S AT ALL CHANGES OF DIRECTIONS AND JOINTS IE'S TO HAVE MARKED COVERS AT GROUND LEVEL

PIPES UNDER BUILDINGS OR WALLS TO HAVE REINFORCED FOUNDATION OVER

NO CHANGE OF DIRECTION OR JUNCTION UNDER BUILDING

ALL WASTEPIPES TO BE 500mm & FULLY ACCESSIBLE

ALL WASTEPIPE APPLICATIONS ON STUBSTACKS TO BE INDIVIDUALLY ANTI-SIPHONED WITH 51mm ANTI-VACUME TRAP

ALL WASTEWATER APPLICATIONS TO HAVE WATERTRAPS SOIL & SEWERPIPES TO BE 1000mm

GEVSERS TO BE ACCORDING TO SARS 0254 **GLAZING ACCORDING TO SABA 0137**

CHIMNEYS ACCORDING TO PART VV1-VV4 OF NBR SHOWERS TO HAVE BRASS TRAPS

10 YEAR WATERPROOFING GUARENTEE TO BE CEDED TO THE CLIENT BY THE CONTRACTOR NO CEMENT BRICKS TO BE USED UNLESS SPECIFIED BY CLIENT, ARCHITECT OR

ALL MASONRY UNITS TO HAVE A COMPRESSIVE STRENGTH NOT LESS THAN

PRINCIPAL AGENT

MASONARY, CEMENT AND CONCRETE NOTES:

BURNT CLAY MASONRY UNITS SHALL COMPLY WITH THE REQUIREMENTS OF CONCRETE MASONRY UNITS SHALL COMPLY WITH THE REQUIREMENTS OF MASONRY WALLING SHALL COMPLY WITH THE REQUIREMENTS OF SANS 2001-

CEMENT USED FOR MORTAR SHALL BE COMMON CEMENTS COMPLYING WITH THE REQUIREMENTS OF SABS ENV 197-1 & MASONRY CEMENTS COMPLYING WITH THE REQUIREMENTS OF SABS ENV 413-1

MORTAR SHALL BE CLASS II HAVING A MIN. COMPRESSIVE STRENGTH AT 28 DAYS OF 7MPa AS PER SABS 0164-1

PRECAST CONCRETE LINTELS USED FOR STRUCTURAL PURPOSES SHALL COMPLY WITH THE REQUIREMENTS OF SANS 1504

REVISION:

DESCRIPTION



Pieter J. Mathews B.Arch(UP) SACA MIArch(SA)

Nr. 4972

Jannes Hattingh

MArch(Prof) PrArch

DATE

Municipal Approval

Architects stamp and signature
the the
Client signature
Other

Project Description | Huis van Niekerk

Project Address ERF 2924


Welbedaght Knysna

Client Name

CHARL LE ROUX VAN NIEKERK

	Project Number
	22314
	Project Name
	Huis van Niekerk
	Sheet Name
	DOOR SCHEDULE

Drawing Number	Revision
M800	
Date	Scale
2023/10/13 10:25:26	1 : 50
Drawn:	Checked by:
K Peinke	PJ Mathews
COPYRIGHT ART 21(1) 98/1978	

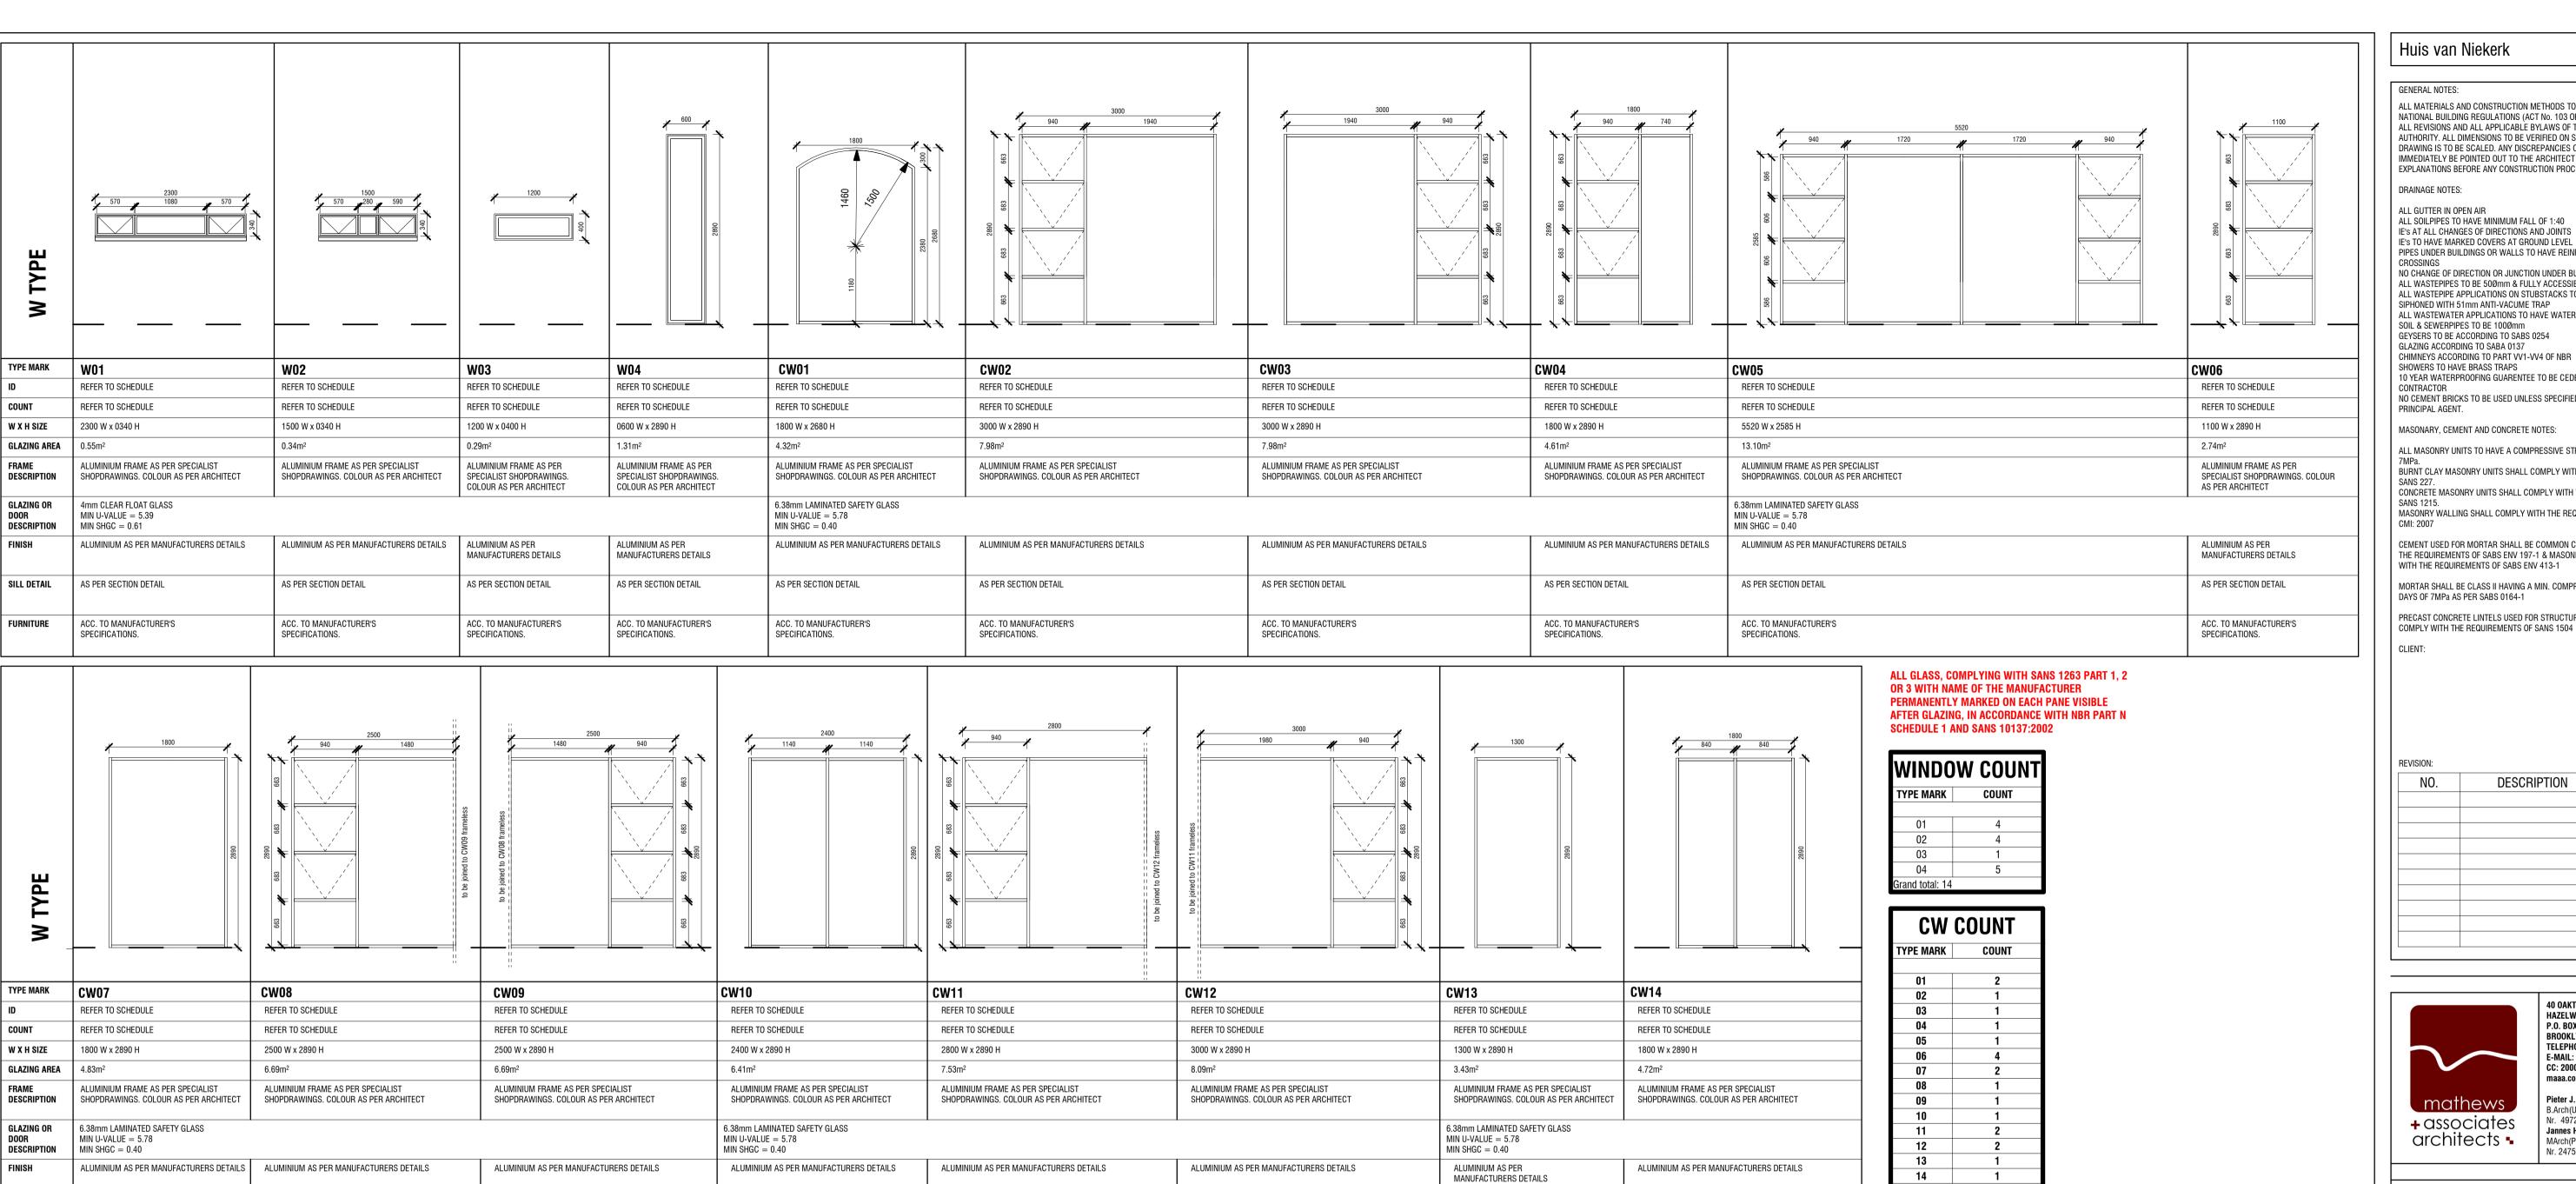

AS PER SECTION DETAIL

ACC. TO MANUFACTURER'S

SPECIFICATIONS.

AS PER SECTION DETAIL

ACC. TO MANUFACTURER'S

SPECIFICATIONS.

AS PER SECTION DETAIL

ACC. TO MANUFACTURER'S

SPECIFICATIONS.

SILL DETAIL

FURNITURE

AS PER SECTION DETAIL

ACC. TO MANUFACTURER'S

SPECIFICATIONS.

FOR DISCUSSION ONLY PRELIMINARY WINDOW SCHEDULE

Grand total: 21

Huis van Niekerk

GENERAL NOTES:

ALL MATERIALS AND CONSTRUCTION METHODS TO COMPLY WITH THE NATIONAL BUILDING REGULATIONS (ACT No. 103 OF 1997) INCLUDING ALL REVISIONS AND ALL APPLICABLE BYLAWS OF THE CONCERNED LOCAL AUTHORITY. ALL DIMENSIONS TO BE VERIFIED ON SITE AND NO DRAWING IS TO BE SCALED. ANY DISCREPANCIES OR CONTRADICTIONS MUST IMMEDIATELY BE POINTED OUT TO THE ARCHITECT FOR CORRECTION OR EXPLANATIONS BEFORE ANY CONSTRUCTION PROCEED.

DRAINAGE NOTES:

ALL GUTTER IN OPEN AIR

ALL SOILPIPES TO HAVE MINIMUM FALL OF 1:40 IE'S AT ALL CHANGES OF DIRECTIONS AND JOINTS IE'S TO HAVE MARKED COVERS AT GROUND LEVEL

PIPES UNDER BUILDINGS OR WALLS TO HAVE REINFORCED FOUNDATION OVER NO CHANGE OF DIRECTION OR JUNCTION UNDER BUILDING

ALL WASTEPIPES TO BE 500mm & FULLY ACCESSIBLE
ALL WASTEPIPE APPLICATIONS ON STUBSTACKS TO BE INDIVIDUALLY ANTI-SIPHONED WITH 51mm ANTI-VACUME TRAP

ALL WASTEWATER APPLICATIONS TO HAVE WATERTRAPS

SOIL & SEWERPIPES TO BE 1000mm GEYSERS TO BE ACCORDING TO SABS 0254 **GLAZING ACCORDING TO SABA 0137**

SHOWERS TO HAVE BRASS TRAPS 10 YEAR WATERPROOFING GUARENTEE TO BE CEDED TO THE CLIENT BY THE CONTRACTOR NO CEMENT BRICKS TO BE USED UNLESS SPECIFIED BY CLIENT, ARCHITECT OR

MASONARY, CEMENT AND CONCRETE NOTES:

ALL MASONRY UNITS TO HAVE A COMPRESSIVE STRENGTH NOT LESS THAN

BURNT CLAY MASONRY UNITS SHALL COMPLY WITH THE REQUIREMENTS OF CONCRETE MASONRY UNITS SHALL COMPLY WITH THE REQUIREMENTS OF

SANS 1215. MASONRY WALLING SHALL COMPLY WITH THE REQUIREMENTS OF SANS 2001-

CEMENT USED FOR MORTAR SHALL BE COMMON CEMENTS COMPLYING WITH THE REQUIREMENTS OF SABS ENV 197-1 & MASONRY CEMENTS COMPLYING WITH THE REQUIREMENTS OF SABS ENV 413-1

MORTAR SHALL BE CLASS II HAVING A MIN. COMPRESSIVE STRENGTH AT 28 DAYS OF 7MPa AS PER SABS 0164-1

PRECAST CONCRETE LINTELS USED FOR STRUCTURAL PURPOSES SHALL COMPLY WITH THE REQUIREMENTS OF SANS 1504

CLIENT:

NO.	DESCRIPTION	DATE



| Municipal Approval

	_	100	
	/		-
Client signature			
Other			
51101			

Project Description	
roject Description	
Huis van Niekerk	
Project Address	
ERF 2924	
Welbedaght	
Knysna	
Client Name	
CHARL LE ROUX V	/AN NIEKERK

	Project Number
	22314
	Project Name
	Huis van Niekerk
	Sheet Name
	WINDOW SCHEDULE

Drawing Number	Revision
M801	
Date	Scale
2023/10/13 10:25:28	1:50
Drawn:	Checked by:
K Peinke	PJ Mathews
COPYRIGHT ART. 21(1) 98/1978	•